
EMORY UNIVERSITY

WOODRUFF RESIDENTIAL CENTER - BOILER REPLACEMENT 1495 CLIFTON ROAD, ATLANTA, GA 30322

100% CONSTRUCTION DOCUMENTS DECEMBER 8, 2021

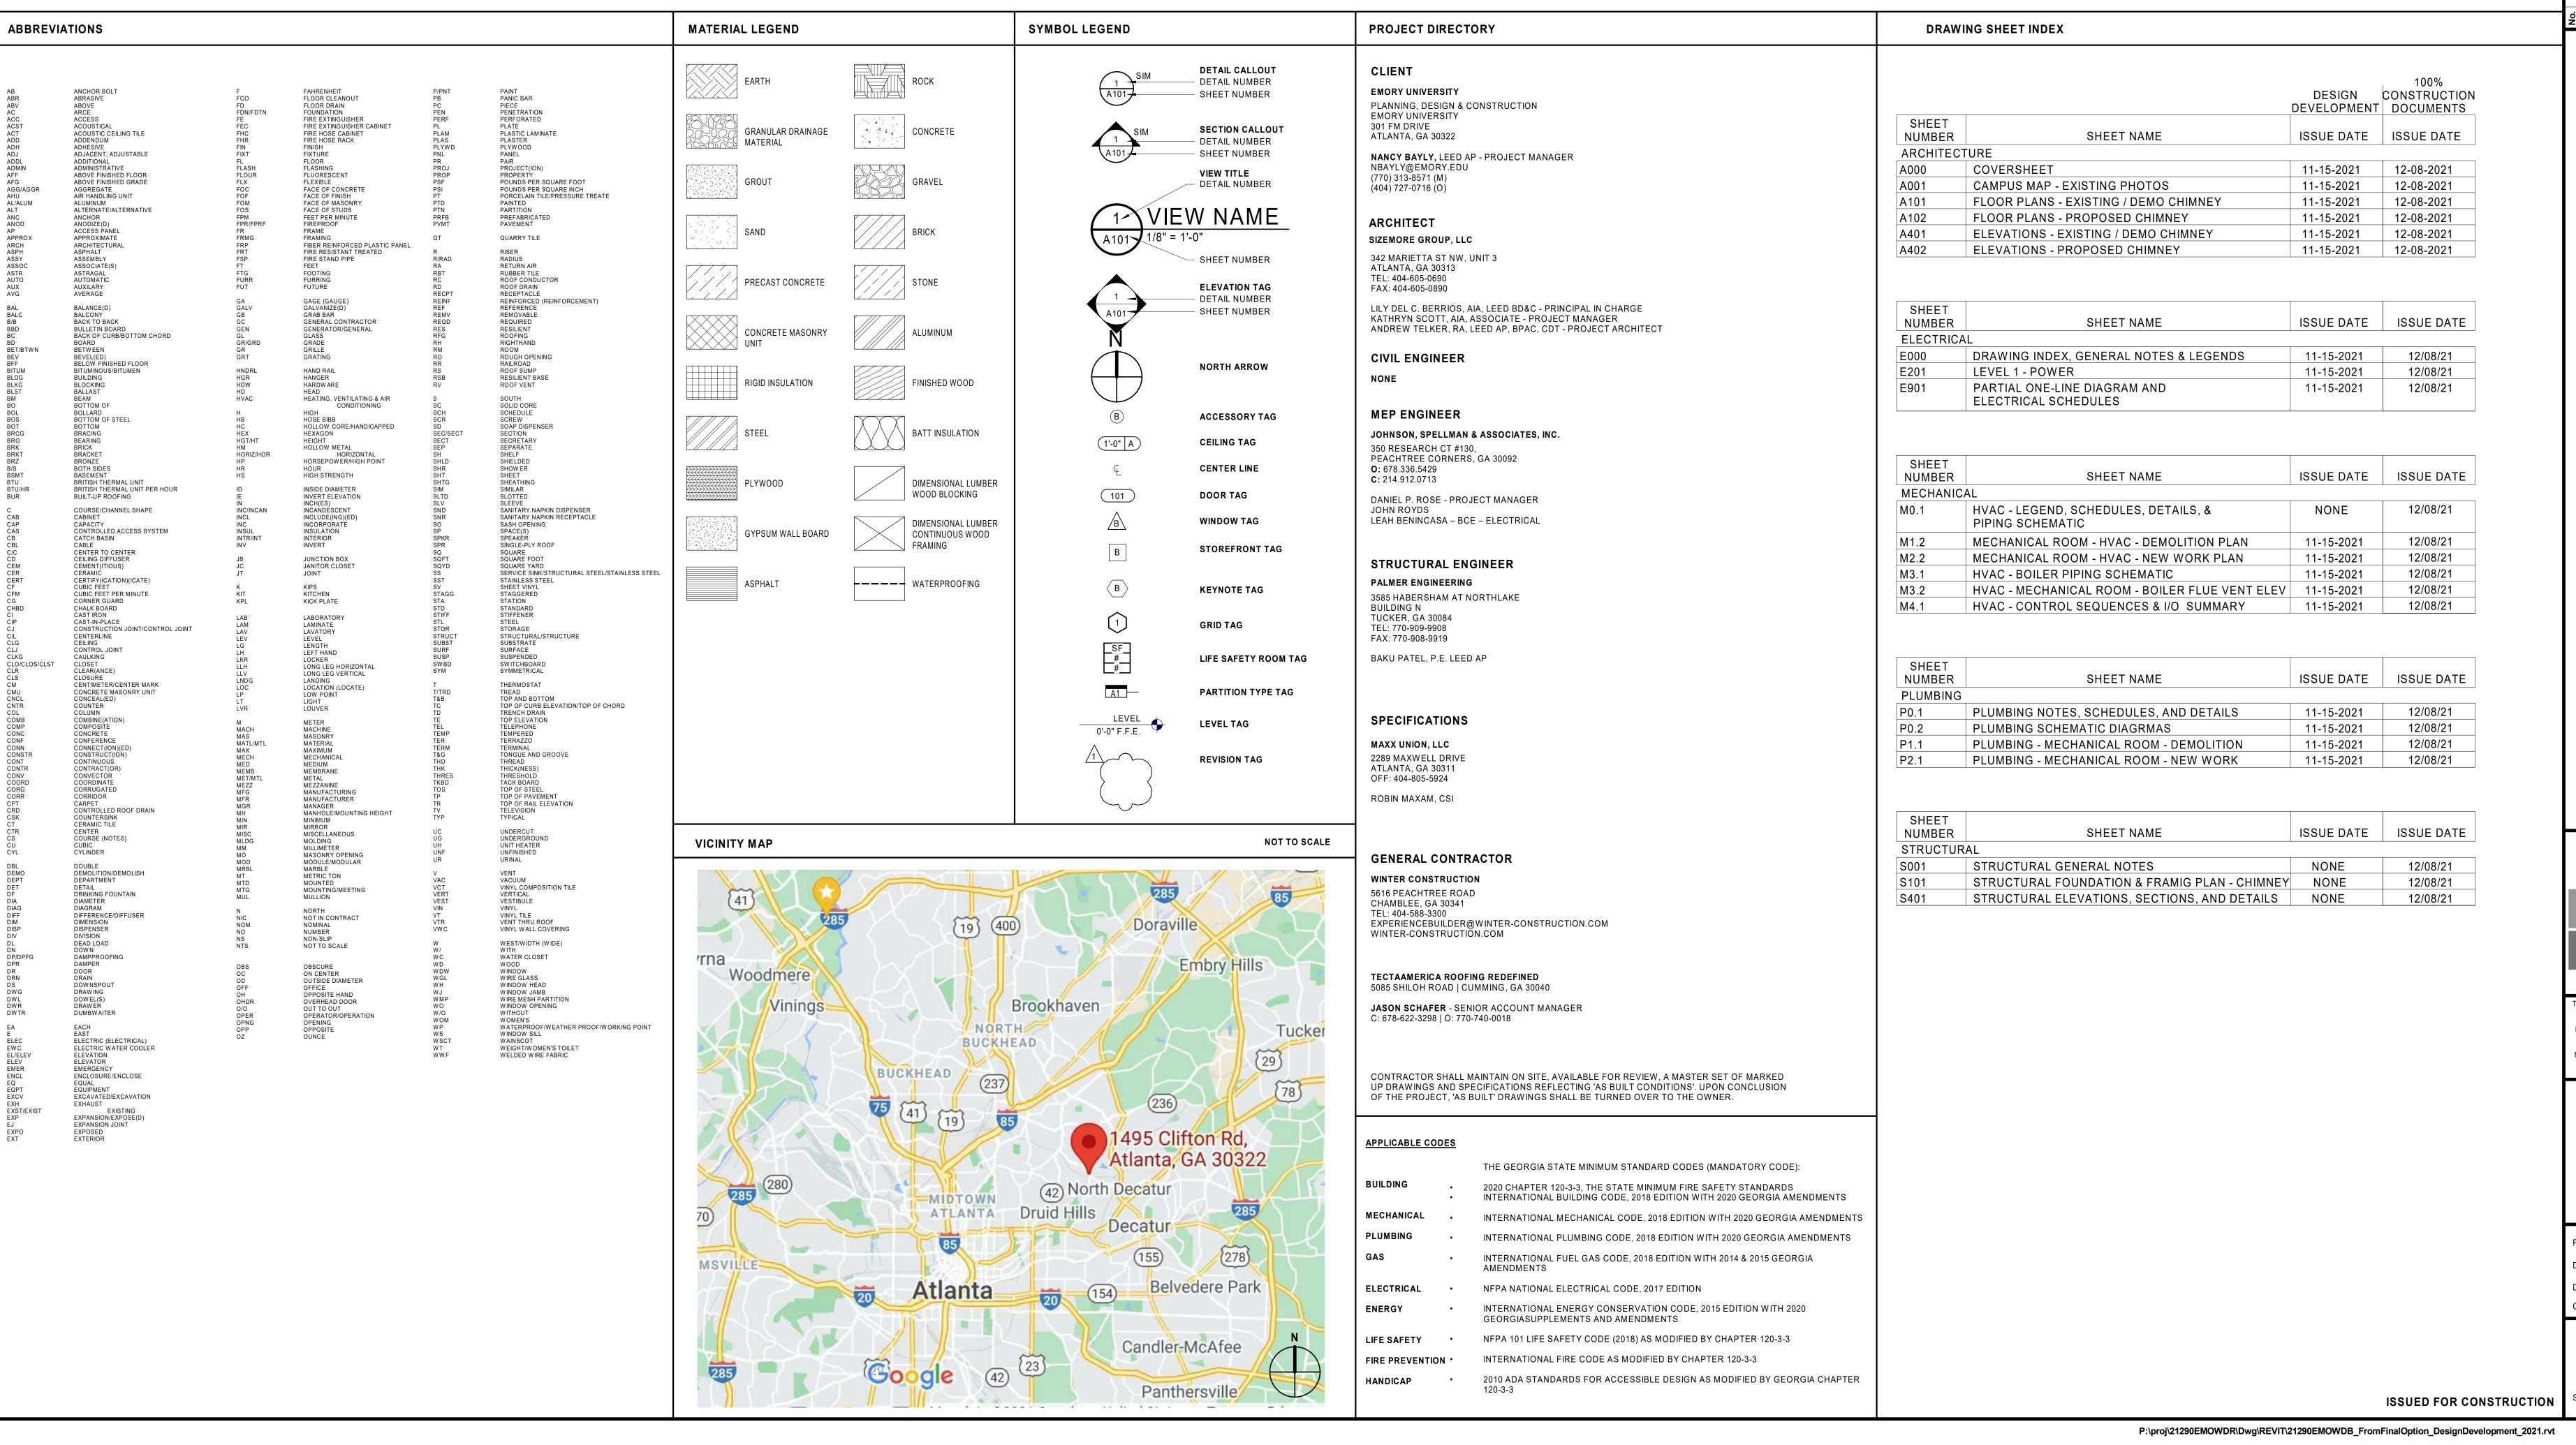

No. DESCRIPTION
1 100% CONSTRUCTION DOCUMENTS
12

SITY - BOILER N ROAD A 30322

IORY ONIVERSOLY

1495 CLIFTON ROA

ATLANTA, GA 3032

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COVERSHEET

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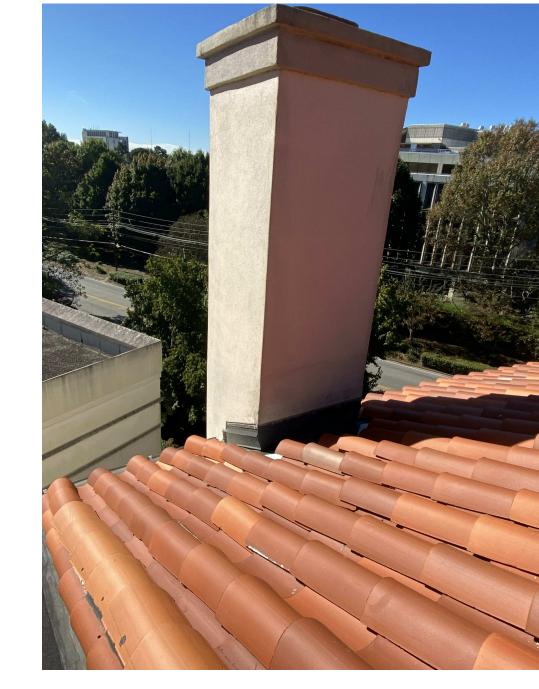
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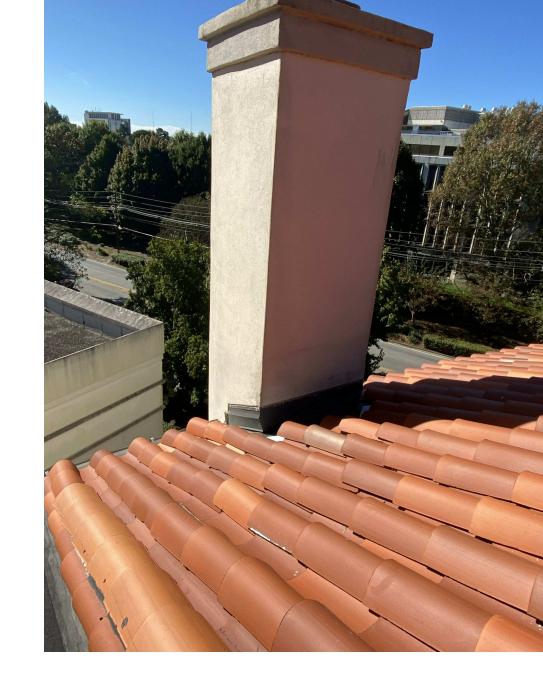
DRAWN BY: A. TELKER


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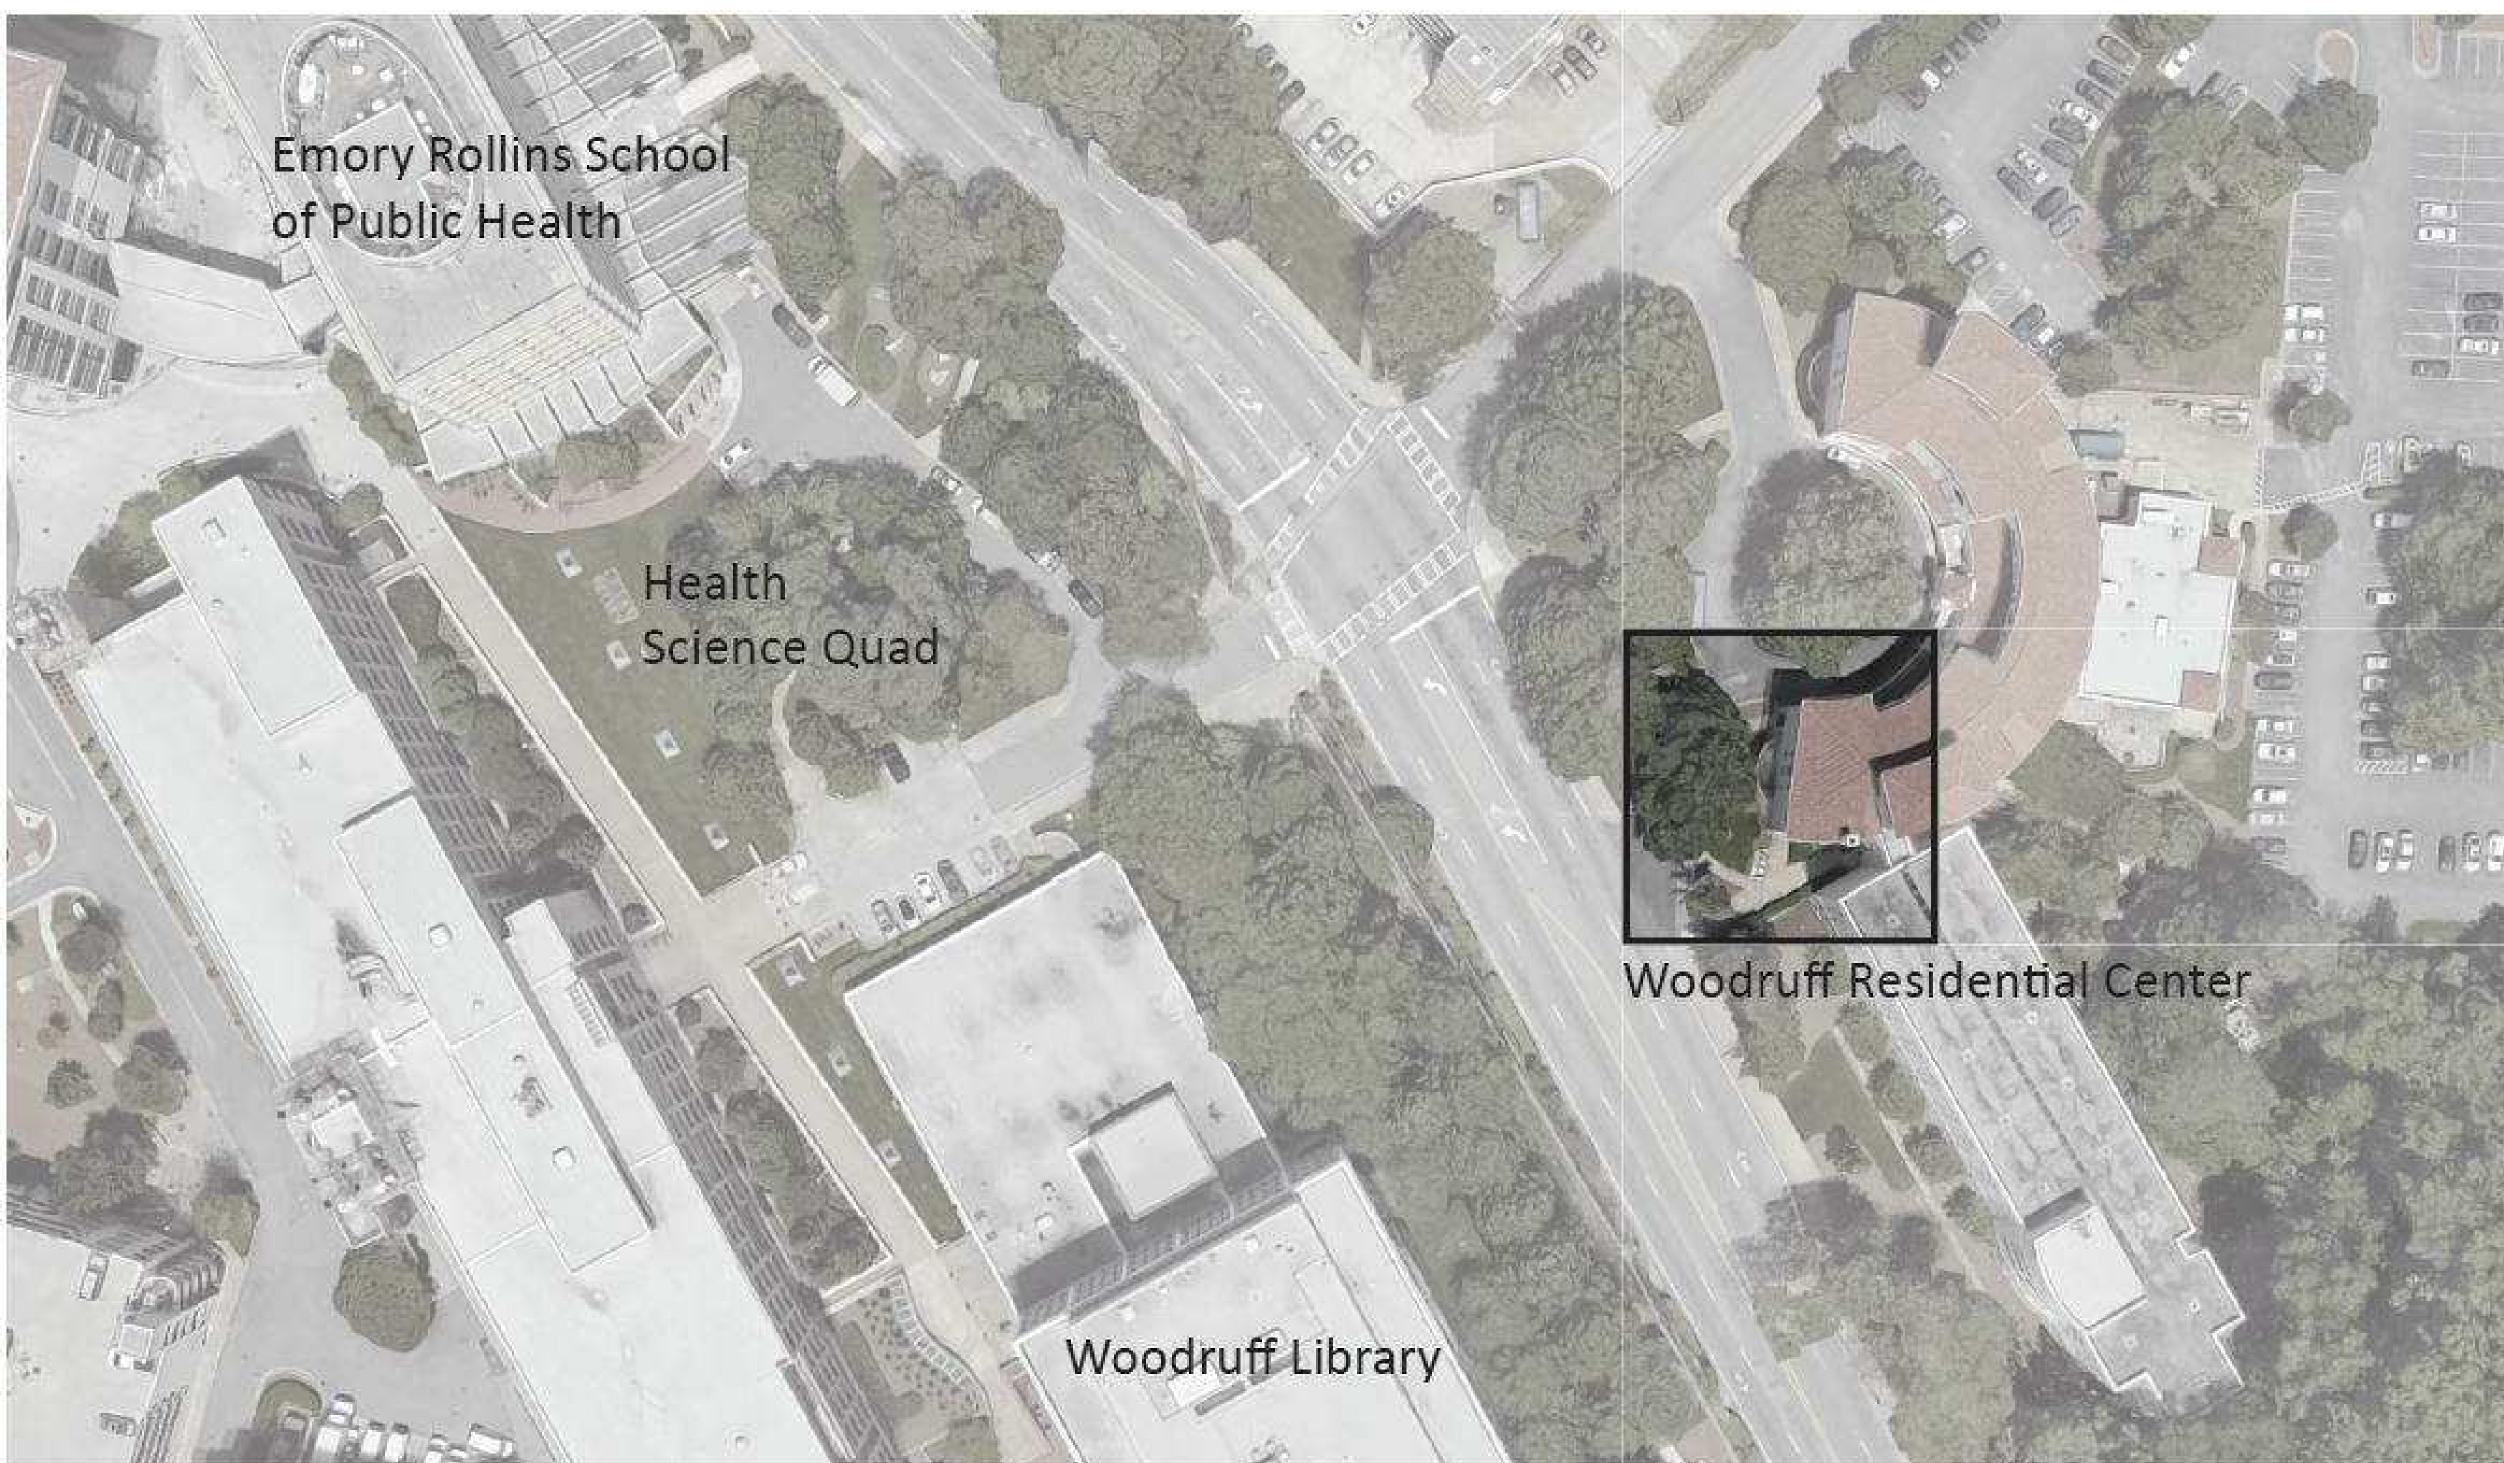
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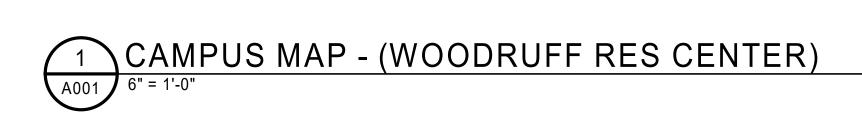













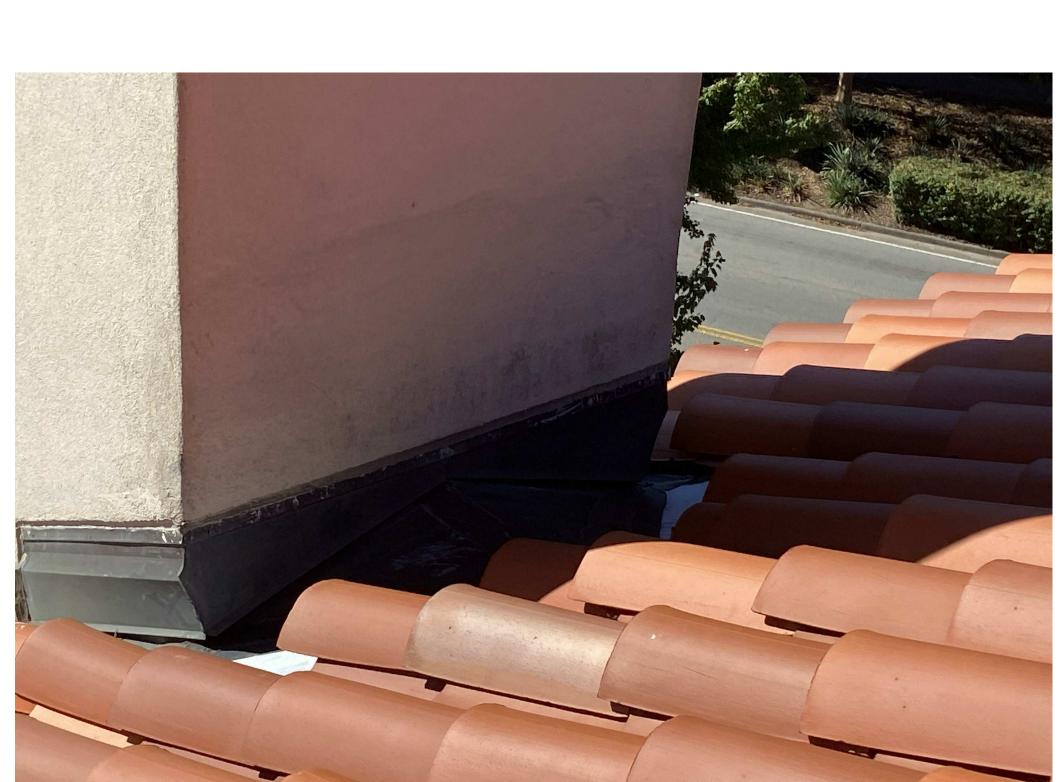

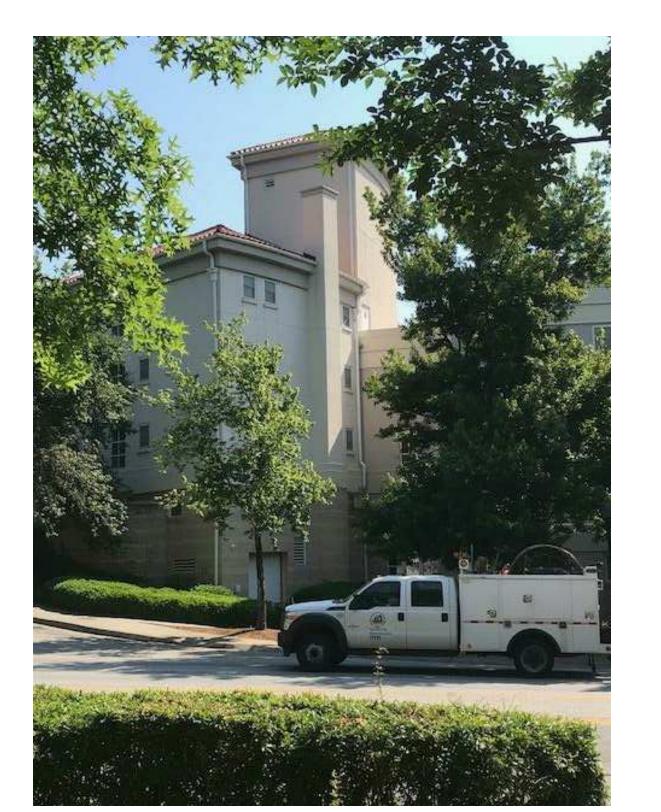

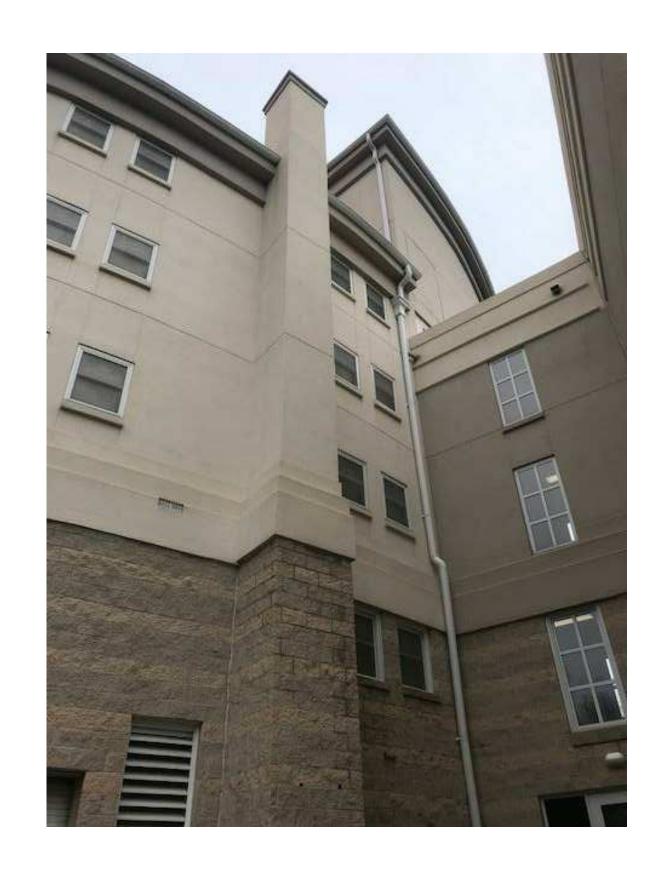

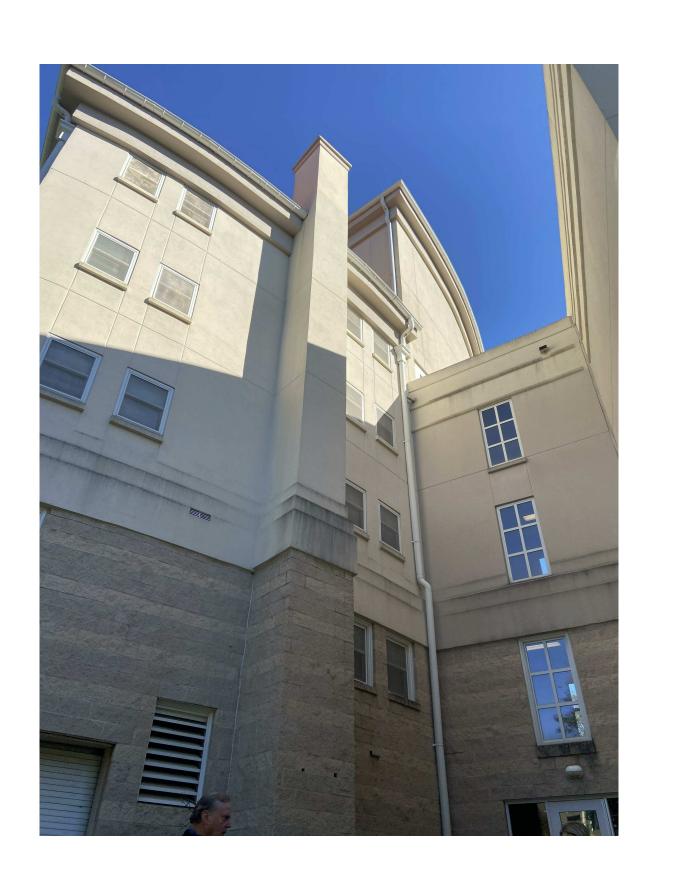




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CAMPUS MAP -EXISTING PHOTOS

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A. TELKER



(PROPOSED) - FLOOR PLAN UPPER FLOOR (5TH)

GENERAL NOTES WTI - SCOPE OF SERVICES

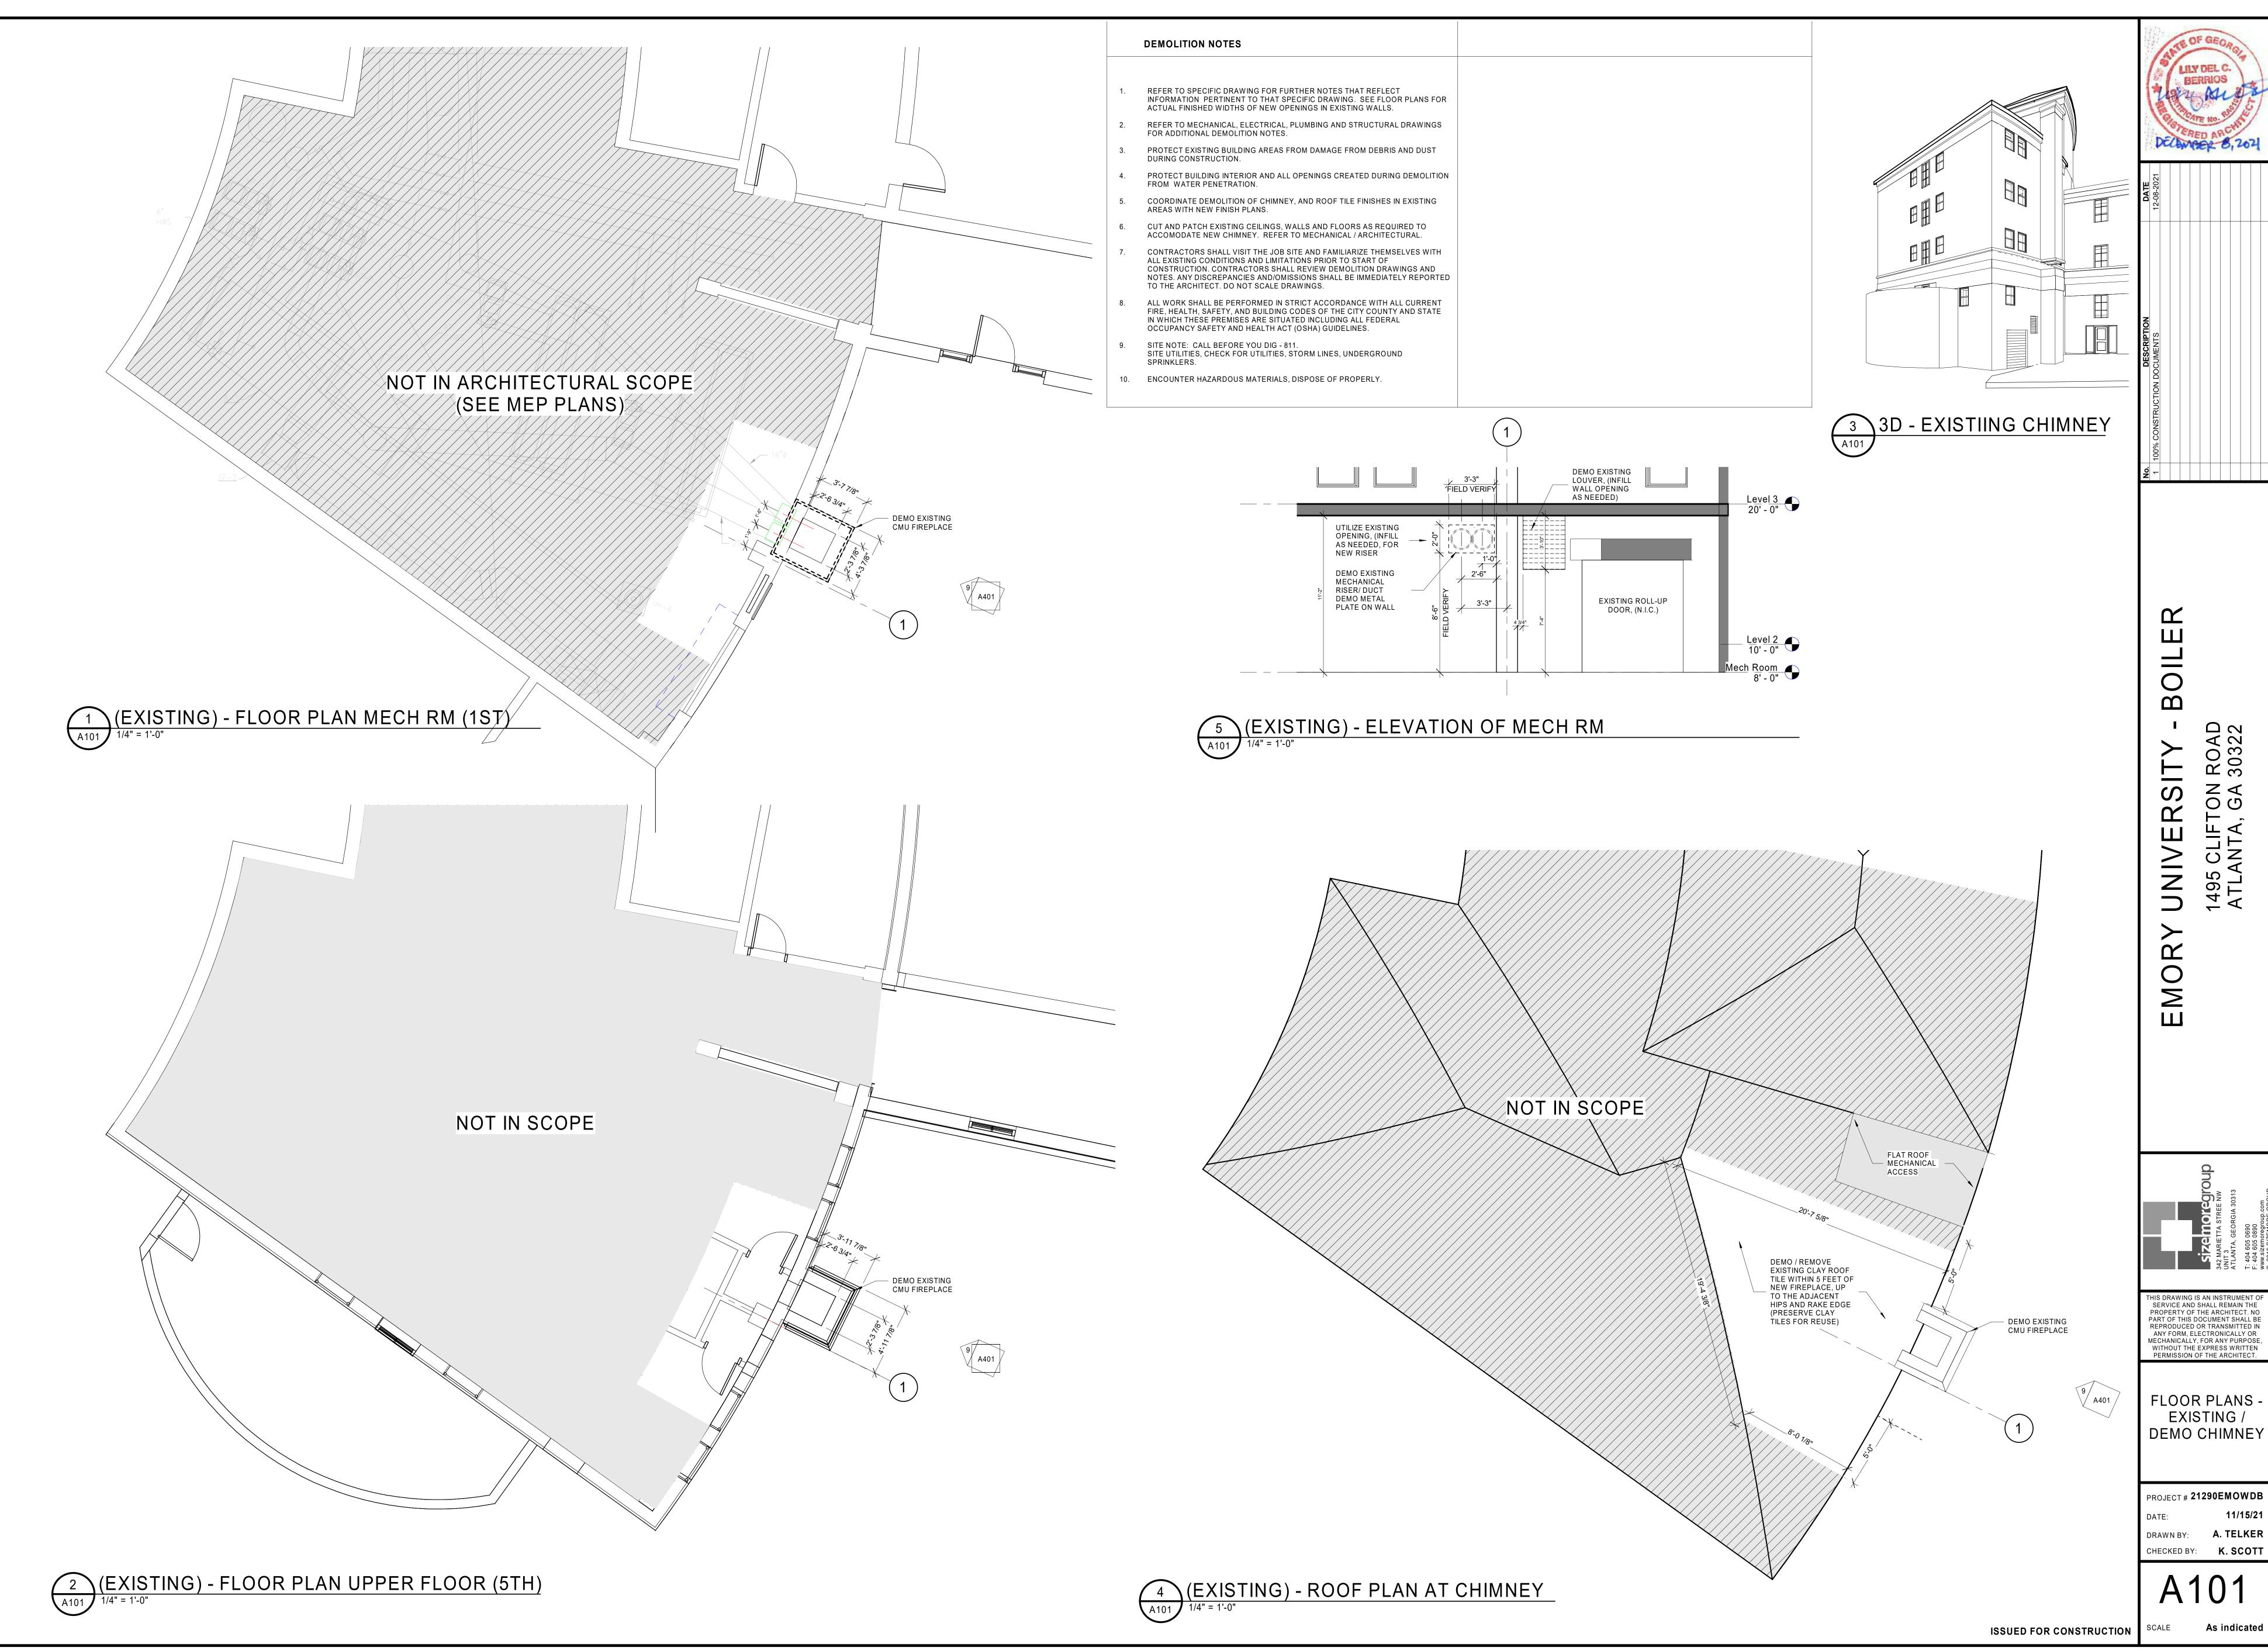- DO NOT SCALE DRAWINGS. ALL DIMENSIONS AND CONDITIONS INDICATED IN THESE DOCUMENTS MUST BE FIELD VERIFIED PRIOR TO CONSTRUCTION. FOR DIMENSIONS NOT SHOWN OR IN QUESTION, CONTRACTOR SHALL REQUEST CLARIFICATION FROM ARCHITECT
- ANY DAMAGE INCURRED DURING CONSTRUCTION SHALL BE FULLY REPLACED.
- NEW GYPSUM BOARD CONSTRUCTION MEETING EXISTING GYPSUM BOARD CONSTRUCTION IN THE SAME SHALL BE FLUSH WITH NO VISIBLE JOINTS SHOWING.
- CONTRACTOR TO PRESERVE ALL DRAINS AND CLEANOUTS UNLESS NOTED OTHERWISE BY KEYNOTES.
- ALL EXISTING WORK, FURNISHINGS, EQUIPMENT OR MATERIAL TO REMAIN THAT ARE DAMAGED BY CONTRACTOR'S OPERATION UNDER THIS CONTRACT SHALL BE RECTIFIED OR REPAIRED AT NO
- ALL DRYWALL FINISH WORK TO BE FINISH LEVEL 4, U.N.O.
- ALL INTERIOR PARTITIONS TO BE TYPE A1, U.N.O.
- SITE NOTE: CALL BEFORE YOU DIG 811. SITE UTILITIES, CHECK FOR UTILITIES, STORM LINES, UNDERGROUND
- PATCH AND GROUT ALL HOLES AND DAMAGED PIECES OF CMU

- REMOVE EXISTING TILE FROM EDGE TO HIP, EIGHT FEET WEST OF THE EXISTING CHIMNEY TO THE EAST SIDEWALL. RETAIN TILES THAT ARE NOT DAMANGED OR DEFECTIVE FOR REUSE.
- CLEAN AND PRIME EXISTING SELF ADHERED UNDER-LAYMENT. INSTALL NEW SELF ADHERING UNDERLAYMENT. ANY UNDERLAYMENT THAT IS NOT SELF ADHERED SHALL BE REMOVED AND REPLACED WITH NEW
- SELF ADHEREING UNDERLAYMENT. REMOVE SECTIONS OF EXISTING DRIP EDGE AND GUTTER TO ACCOMODATE NEW LARGER CHIMNEY. INSTALL END CAPS ON GUTTER
- (MATCH EXISTING METAL COLOR, TYPE, AND THICKNESS). MODIFY EXISTING CRICKET BEHIND CHIMNEY TO ACCOMODATE NEW LARGER CHIMNEY. DRY IN MODIFICATIONS WITH SELF ADHERING
- REINSTALL RETAINED ROOF TILE WITH #8 STAINLESS STEEL SCREWS. OWNER HAS A LIMITED SUPPLY OF ATTIC STOCK ROOF TILE WHICH MAY BE USED TO REPLACE DAMAGED OR DEFECTIVE ROOF TILES. CONTRACTOR TO SUPPLY ANY ADDITIONAL TILE REQUIRED.
- INSTALL NEW SIDEWALL FLASHING AT CHIMNEY AND EAST WALL. INSTALL NEW BACKER FLASHING BEHIND CHIMNEY. INSTALL NEW COUNTERFLASHING AT CHIMNEY. EXISTING COUNTERFLASHING AT EAST WALL MAY BE REUSED IF IN ACCEPTABLE CONDITION. MATCH EXISTING METAL.
- PROVIDE A 2 YEAR CONTRACTORS WARRANTY.


UNDERLAYMENT.



3D - PROPOSED CHIMNEY

NOTE: COORDINATE ALL MECAHNICAL EQUIPMENT PURCHASED AND EXISTING EQUIPMENT WITH NEW OPENINGS EXISTING LOUVER – OPENING, (INFILL WALL AS NEEDED) Level 3 20' - 0" UTILIZE EXISTING OPENING, (INFILL AS NEEDED) _ _ _ _ _ _ SEE MECHANICAL FOR RISER/ DUCT SIZING, METAL PLATE TO WALL **EXISTING ROLL-UP** DOOR, (N.I.C.) NEW LOUVER

(PROPOSED) - ELEVATION OF MECH RM

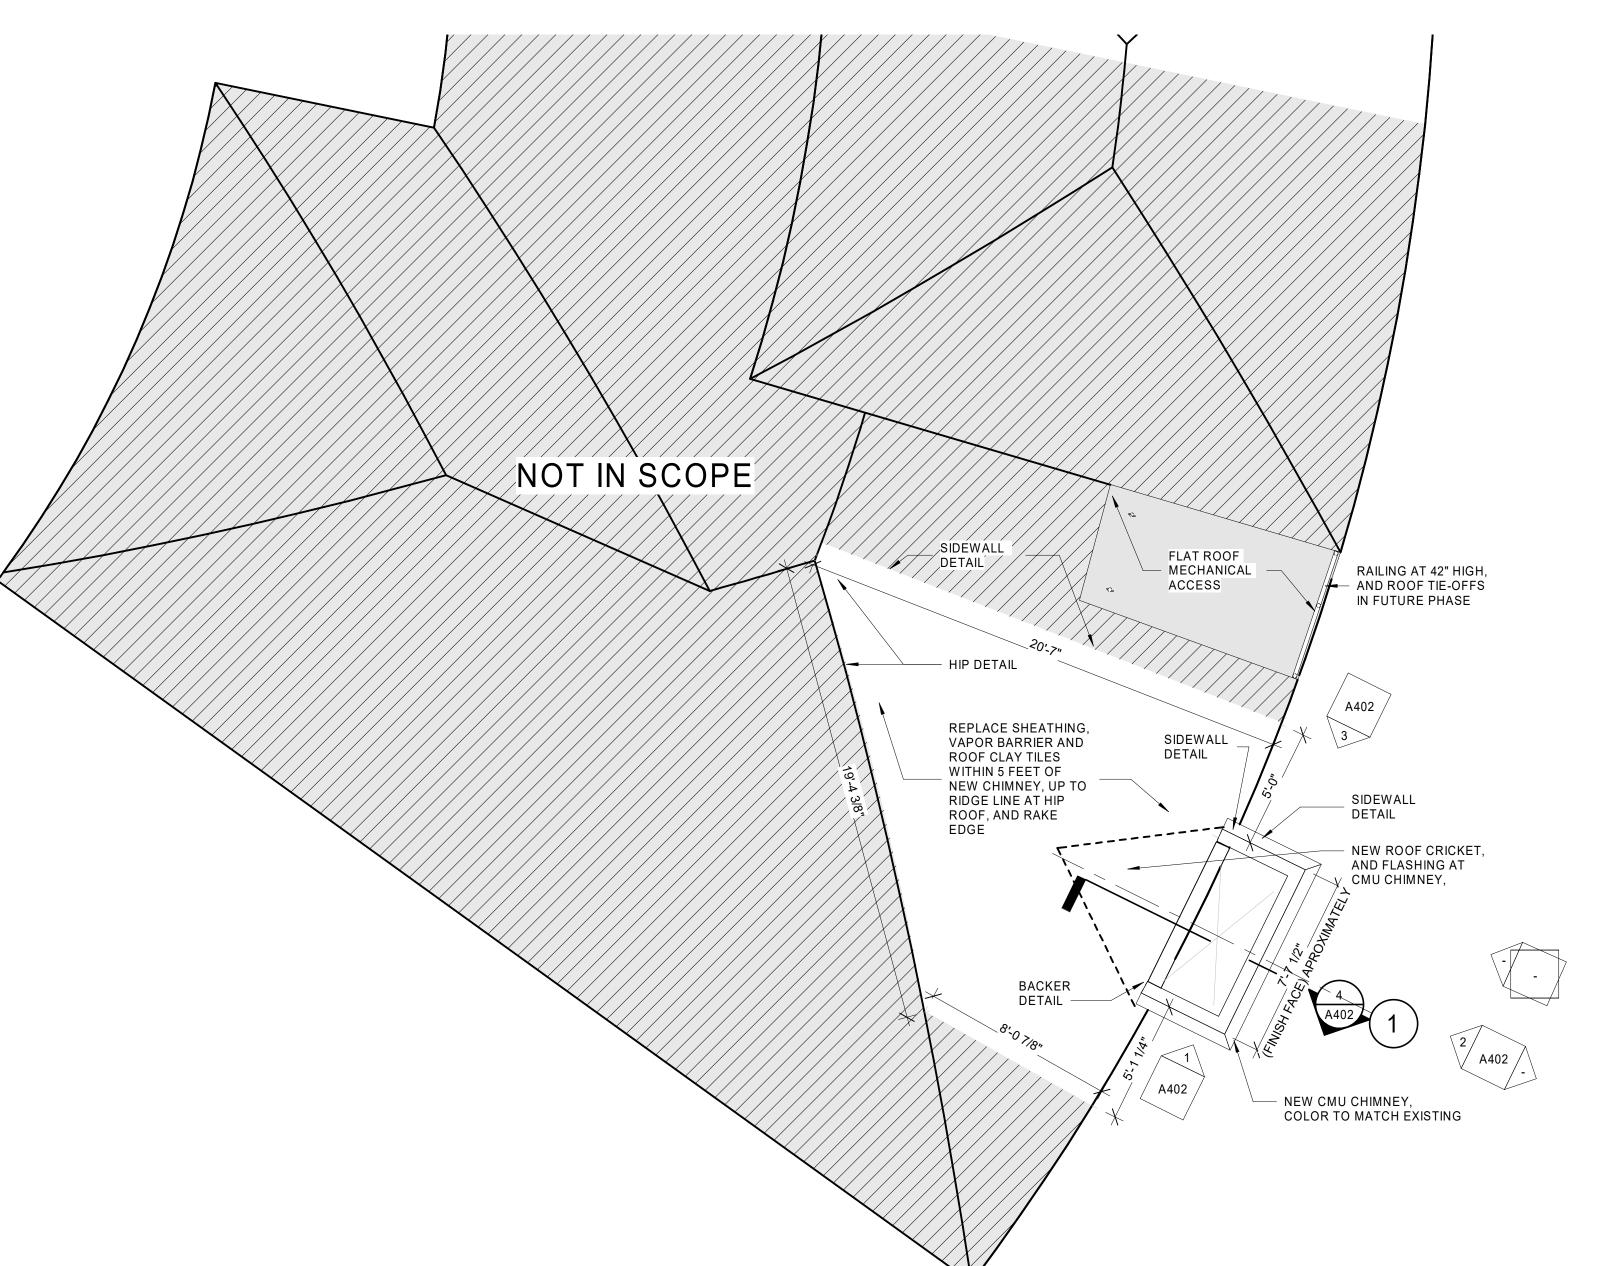

(PRPOSED) - ROOF PLAN AT NEW CHIMNEY

ISSUED FOR CONSTRUCTION

2

DECAMBER 8, 2021

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FLOOR PLANS -PROPOSED CHIMNEY

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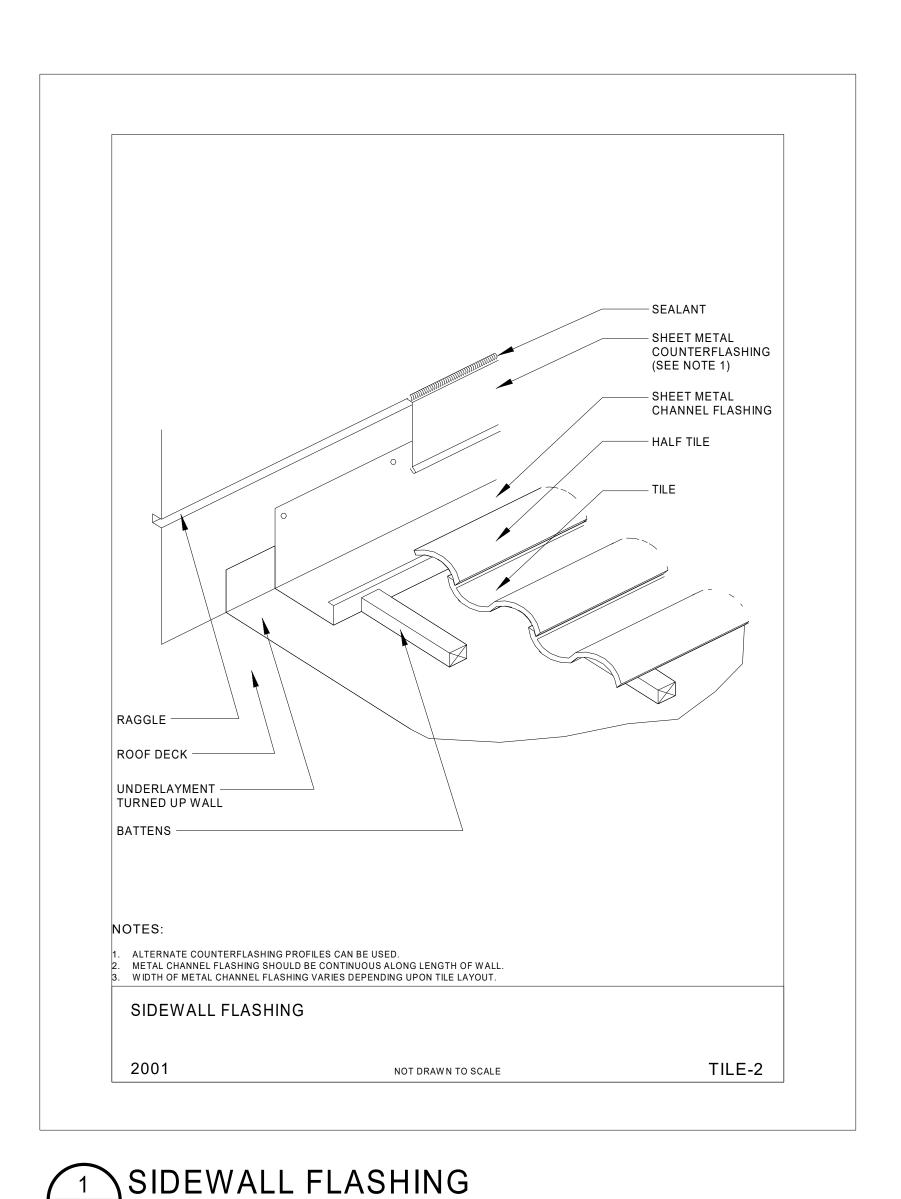
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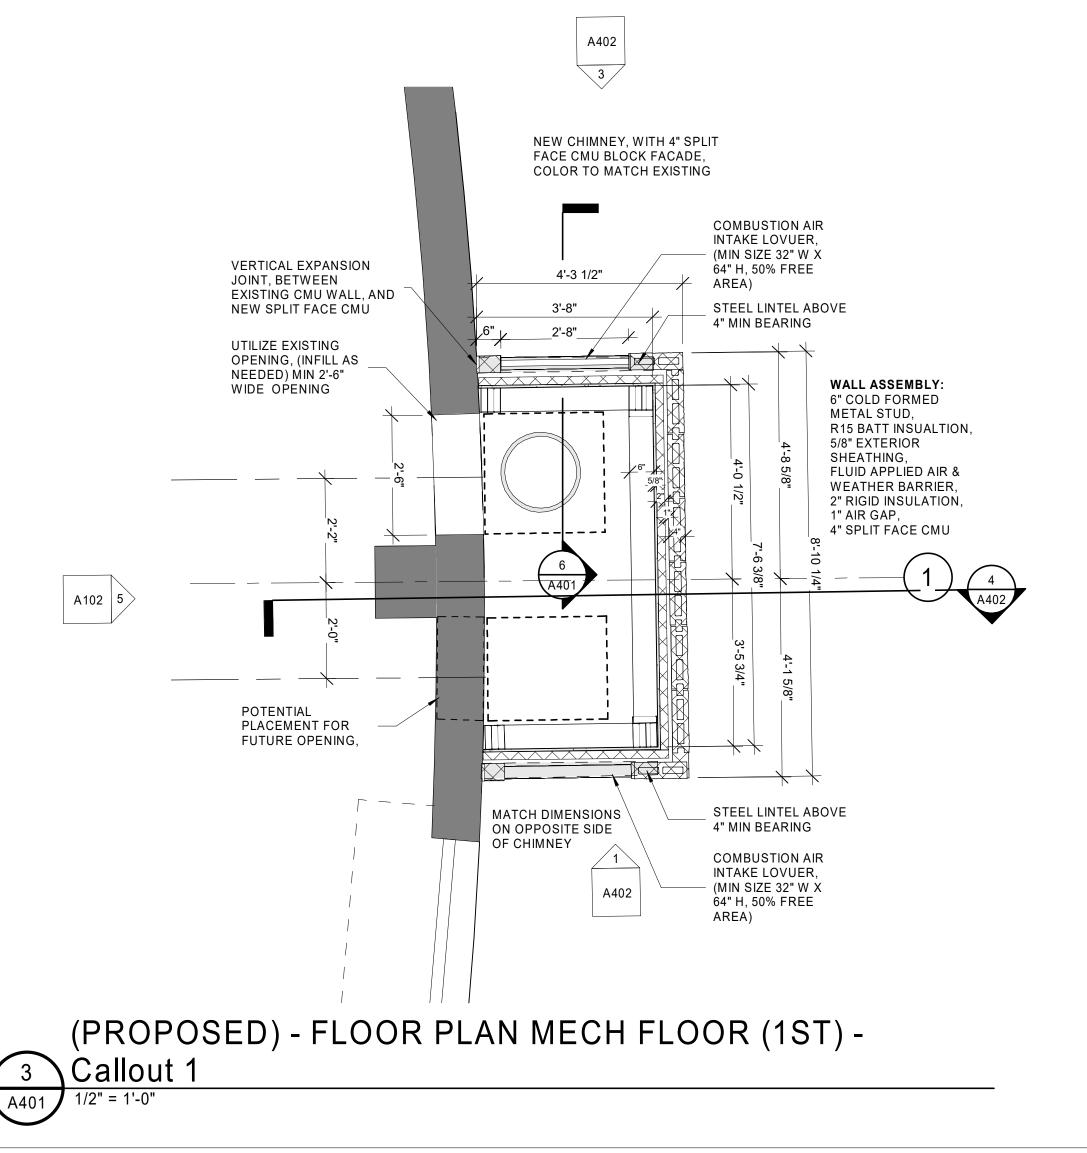
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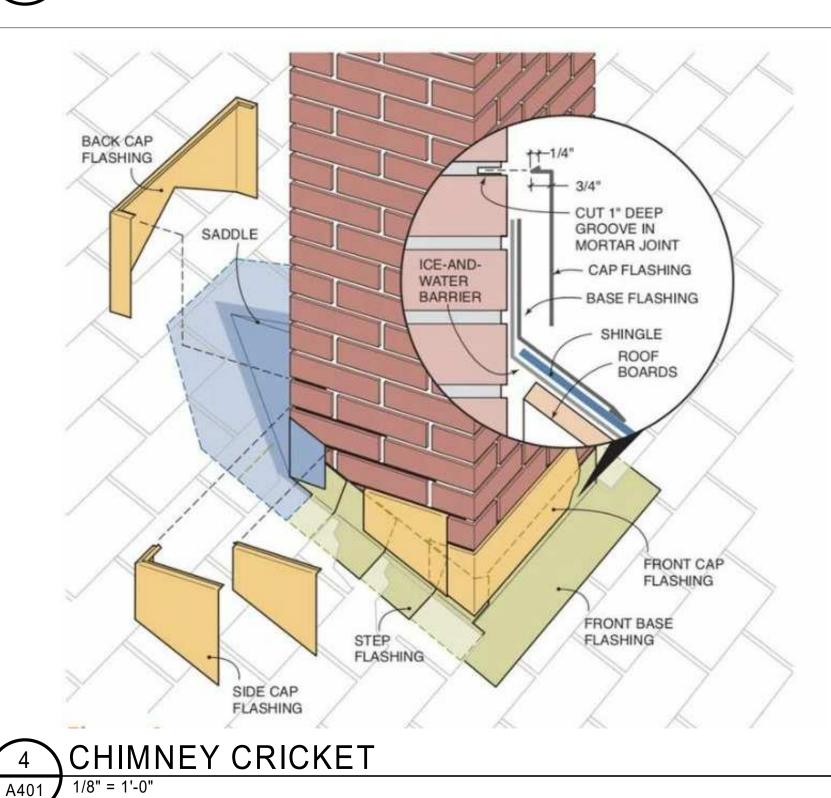
K. SCOTT A102


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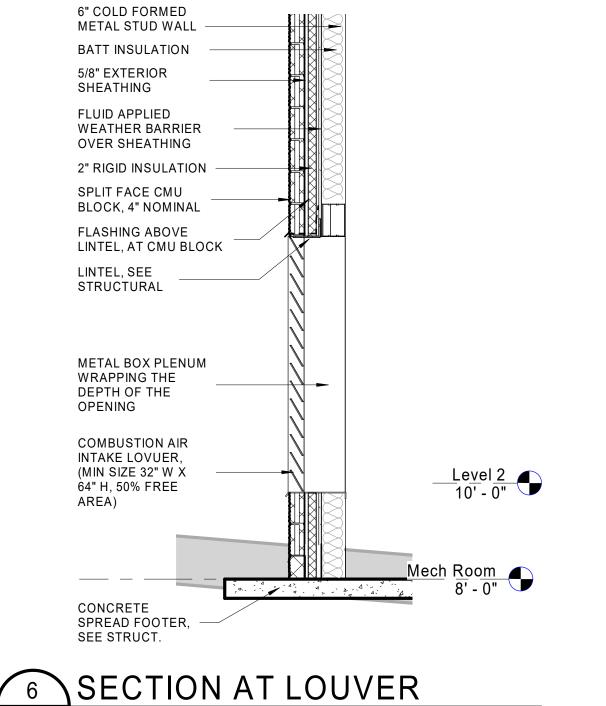







5 CHIMNEY CAP

1/8" = 1'-0"

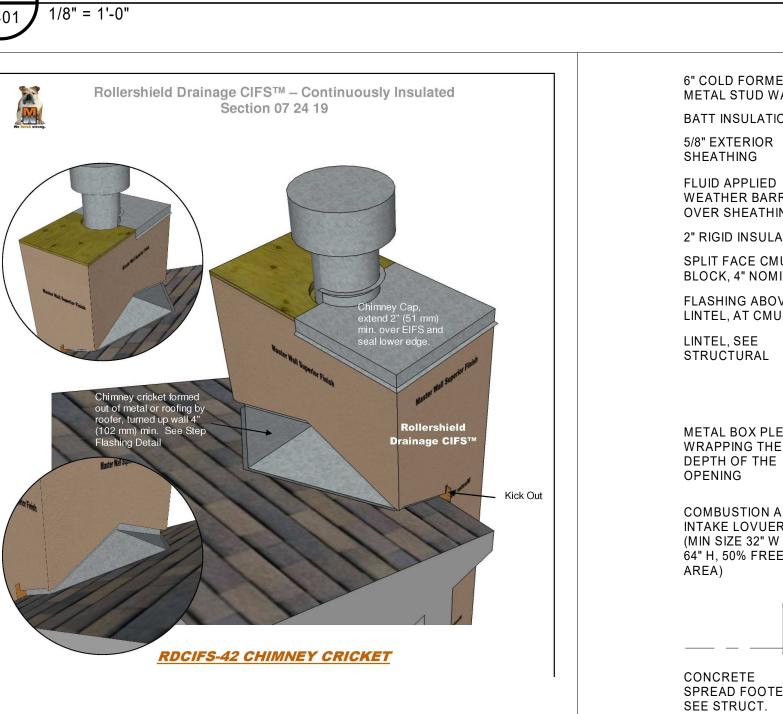

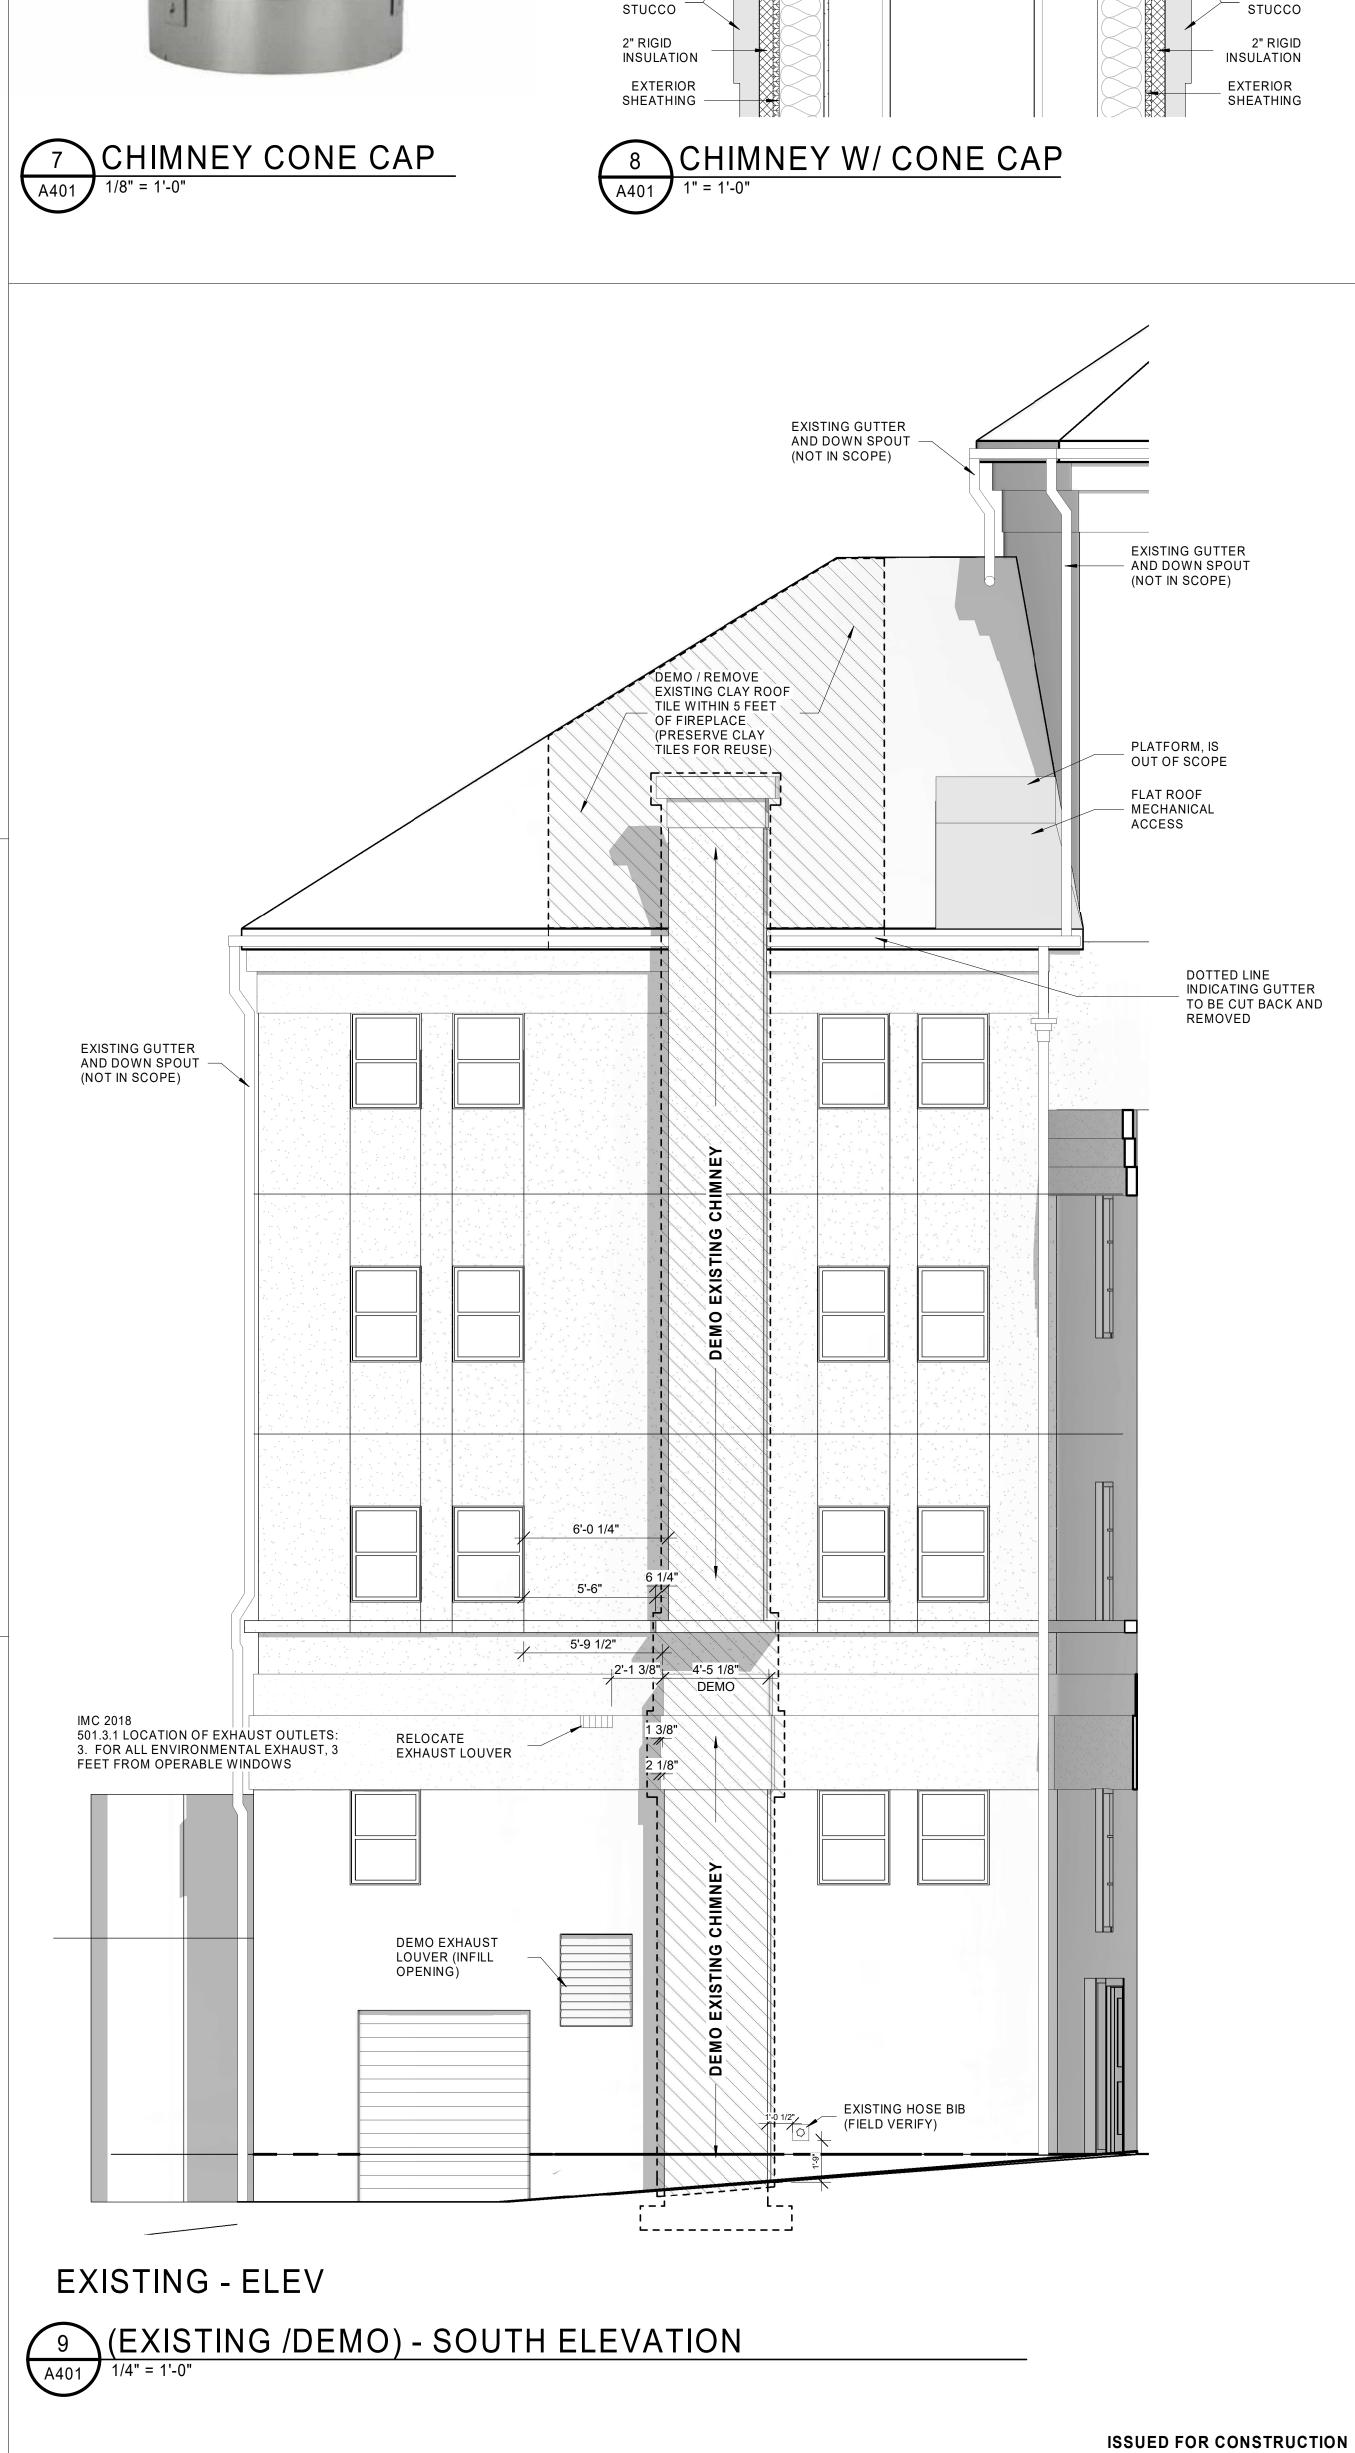

INTERGRAL FLASHING


CHIMNEY CONE CAP
METAL CAP OVER
CHIMNEY TOP

EXTERIOR SHEATHING

CAULK BETWEEN CONE — CAP, AND METAL CAP FLASHING

- W/ 1" INSULATED LINER

20" RISER DUCT

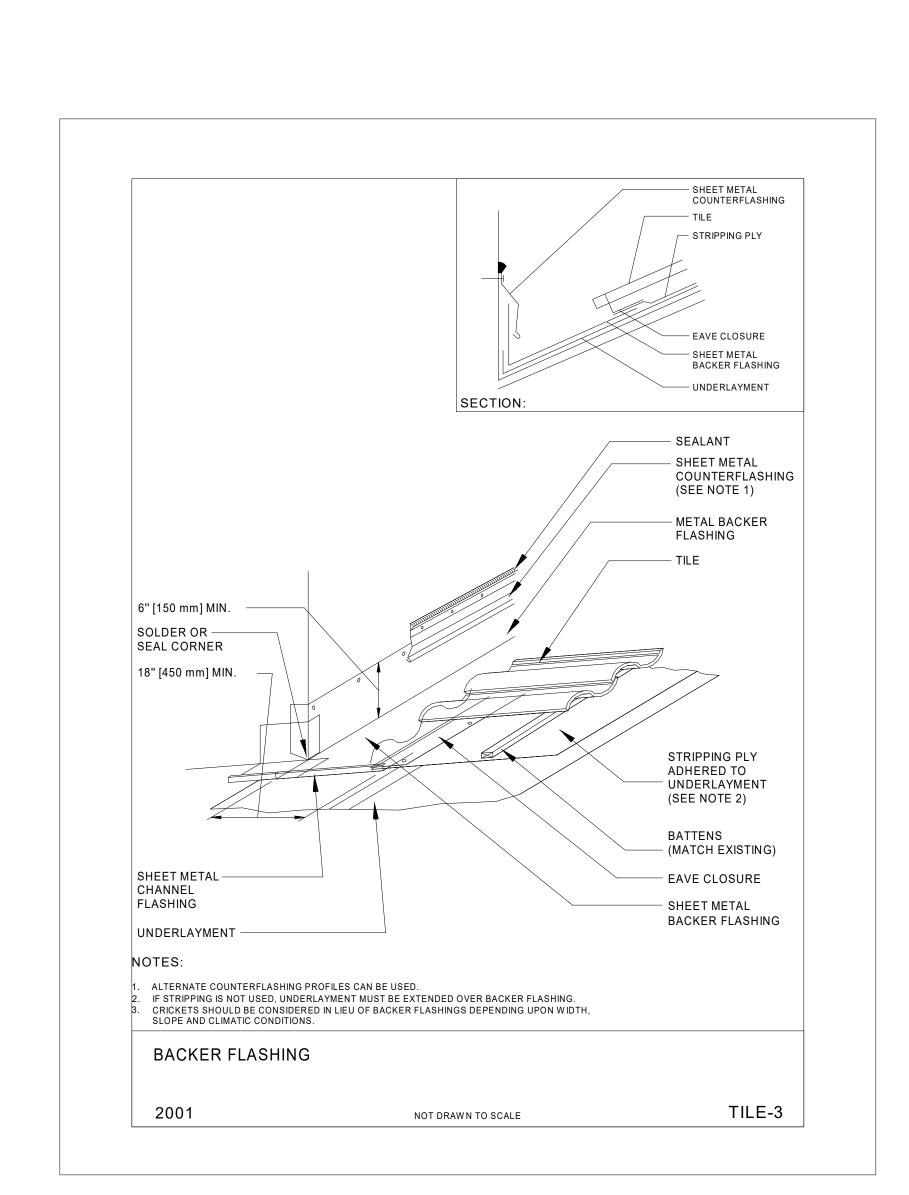

BACKER FLASHING

12" = 1'-0"

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A. TELKER

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ELEVATIONS -

(EXISTING /

DEMO)

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DRAWN BY:

SCALE

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