
# Know what's below. Call before you dig.

# CHERRY EMERSON FIRE SUPPRESSION SYSTEM



VICINITY MAP

SCALE: N.T.S.

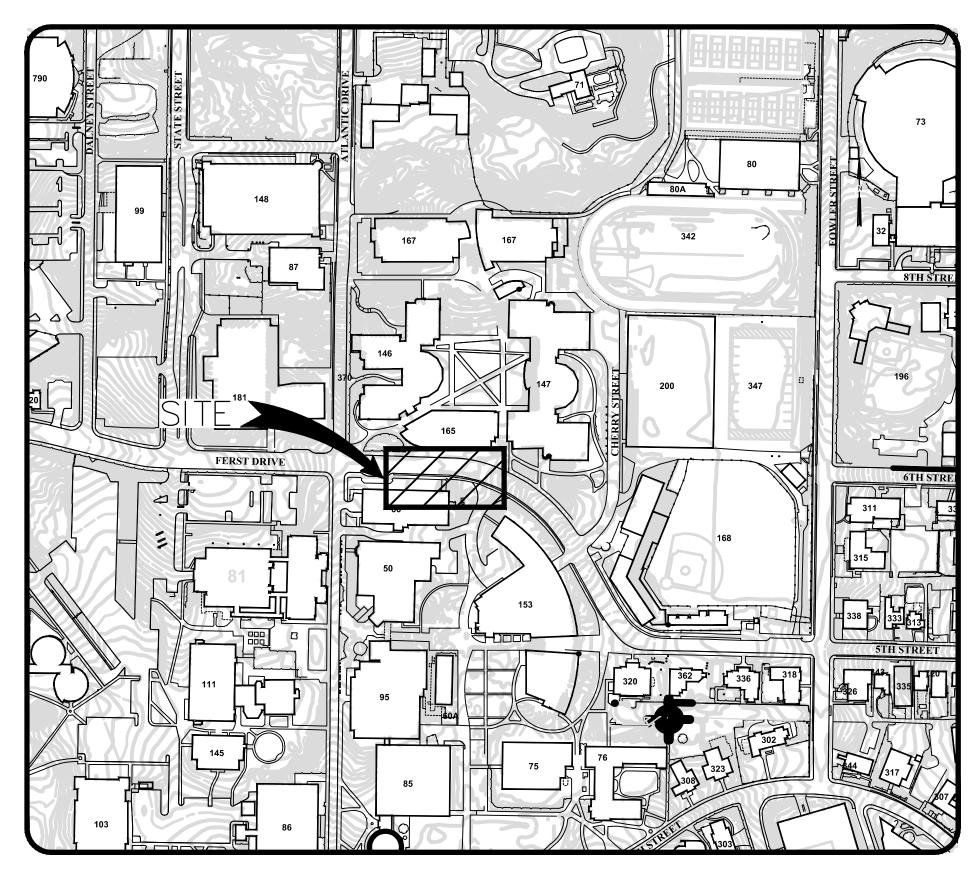

SITE MAP
SCALE: N.T.S.

## BOA

OWNER:

BOARD OF REGENTS OF THE UNIVERSITY SYSTEM OF GEORGIA 270 WASHINGTON STREET, S.W. ATLANTA, GA 30334

### USING AGENCY:

GEORGIA INSTITUTE OF TECHNOLOGY 151 6TH STREET, N.W. CONTACT: NGUGI MATHU PHONE: (470) 428-0160

### **ENGINEER:**

JACOBS ENGINEERING GROUP, INC. 10TH STREET, GEORGIA, 30309 CONTACT: ERIC WESTCOTT PHONE: (404) 978-7600

### 24-HOUR CONTACT:

NGUGI MATHU
GEORGIA INSTITUTE OF TECHNOLOGY
FACILITIES DESIGN & CONSTRUCTION
(470) 428-0160

## AREA SUMMARY:

SITE AREA: DISTURBED AREA: PROPOSED IMPERVIOUS AREA: 0.173 AC 0.173 AC < 1 AC

# PROJECT DESCRIPTION:

- 1. THIS PROJECT IS LOCATED IN LAND LOTS 80 & 81 OF THE
- 14TH & 17TH DISTRICT OF FULTON COUNTY, GA.

  2. THE PROJECT SITE IS LOCATED ON THE NORTHEAST QUADRANT OF THE CAMPUS OF THE GEORGIA INSTITUTE OF TECHNOLOGY IN ATLANTA, FULTON COUNTY, GEORGIA.
- 3. THE PROJECT PROPOSES A NEW UNDERGROUND FIRE SUPRESSION
- MAIN, ALONG WITH BACKFLOW PREVENTION EQUIPMENT.

  4. BOUNDARY AND TOPOGRAPHIC SURVEY INFORMATION TAKEN FROM: A SURVEY BY JACOBS 02/01/2016. ADDITIONAL SURVEY INFORMATION SHOWN FROM SURVEYS PREPARED FOR GEORGIA INSTITUTE OF TECHNOLOGY BY JACOBS, FOR EARLIER PROJECTS. SEE NOTES ON INDIVIDUAL SHEETS FOR ADDITIONAL INFORMATION. THESE SURVEYS MAY BE OUT OF DATE AND NOT REFLECT CURRENT SITE CONDITIONS.
- 5. THIS SITE IS NOT LOCATED WITHIN A 100 YEAR FLOOD ZONE ACCORDING TO THE FEDERAL EMERGENCY MANAGEMENT AGENCY FLOOD INSURANCE RATE MAP COMMUNITY PANEL NUMBER 13121C0244E MAP WITH PRELIMINARY DATE OF OCTOBER 7, 2011.

SHEET INDEX							
Sheet Number	Sheet Title						
C-001	COVER SHEET						
CX-001	EXISTING CONDITIONS						
CS-001	SITE PLAN						
CS-201	UTILITY PROFILE						
CS-501	SITE DETAILS						
CS-502	SITE DETAILS						
CE-101	EROSION CONTROL SINGLE PHASE						
CE-501	EROSION CONTROL DETAILS						

# Jacok



EGENTS UNIVERSITY SYSTEM OF GEORG RGIA INSTITUTE OF TECHNOLOGY

									11/13/2020 ISSUED TO OWNER	REVISION DESCRIPTION
									11/13/2020	DATE
									0	REV
THIS LINE IS ONE INCH										

THIS LINE LONG WHEN PLOTTED FULL SCALE

THIS DRAWING MUST BE USED IN CONJUNCTION WITH THE APPLICABLE OR GOVERNING TECHNICAL SPECIFICATIONS AND OTHER CONTRACT DOCUMENTS.

PROJECT NO: EEXJ9202

DATE: OCTOBER 2020

DISC. LEAD: DESIGNER: CHECKER: ERW MSK PLP


SHEET TITLE


CIVIL


COVER SHEET


C-001

THIS SITE HAS GEORGIA TECH OWNED UTILITIES LOCATED ON IT. PRIOR TO CONSTRUCTION, THE CONTRACTOR IS TO FILL OUT A UTILITIES LOCATE FORM. THE FORM CAN BE FOUND AT WWW.FACILITIES.GATECH.EDU WEBSITE. THE CONTRACTOR IS TO FOLLOW DIRECTIONS ON THE FORM FOR THE REQUEST SUBMITTAL AND PROVIDE A COPY OF THE FORM TO THE PROJECT MANAGER.

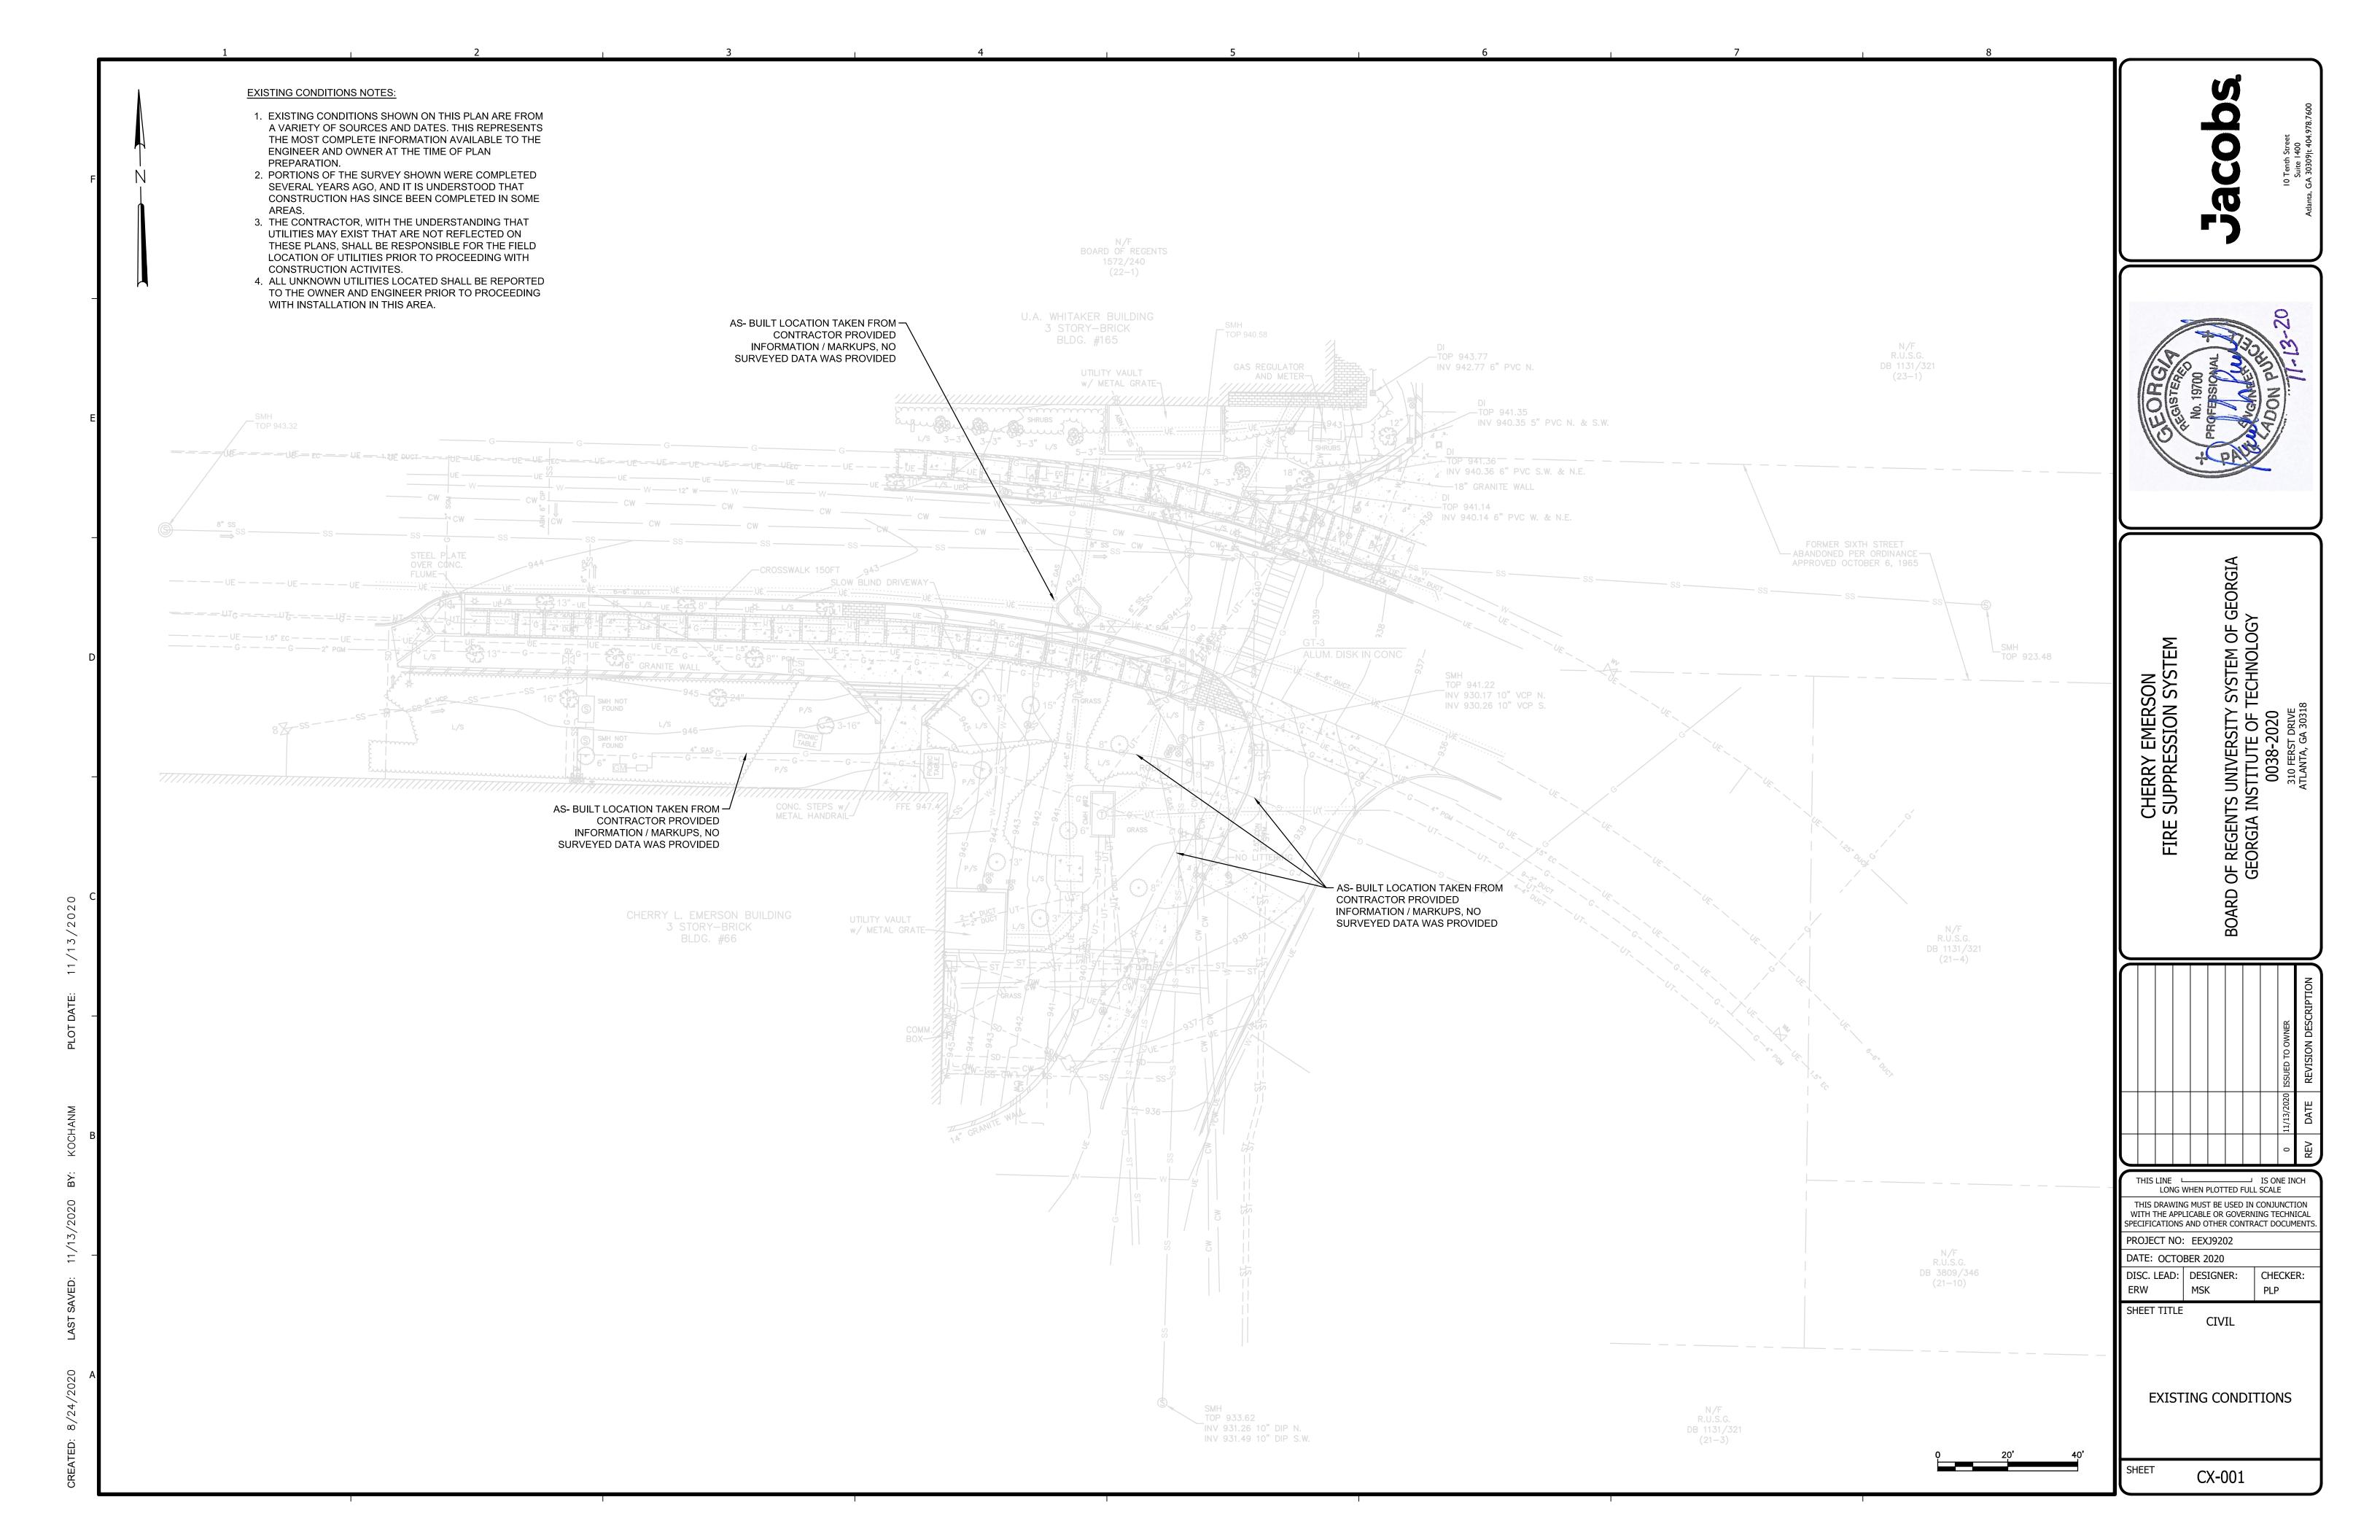

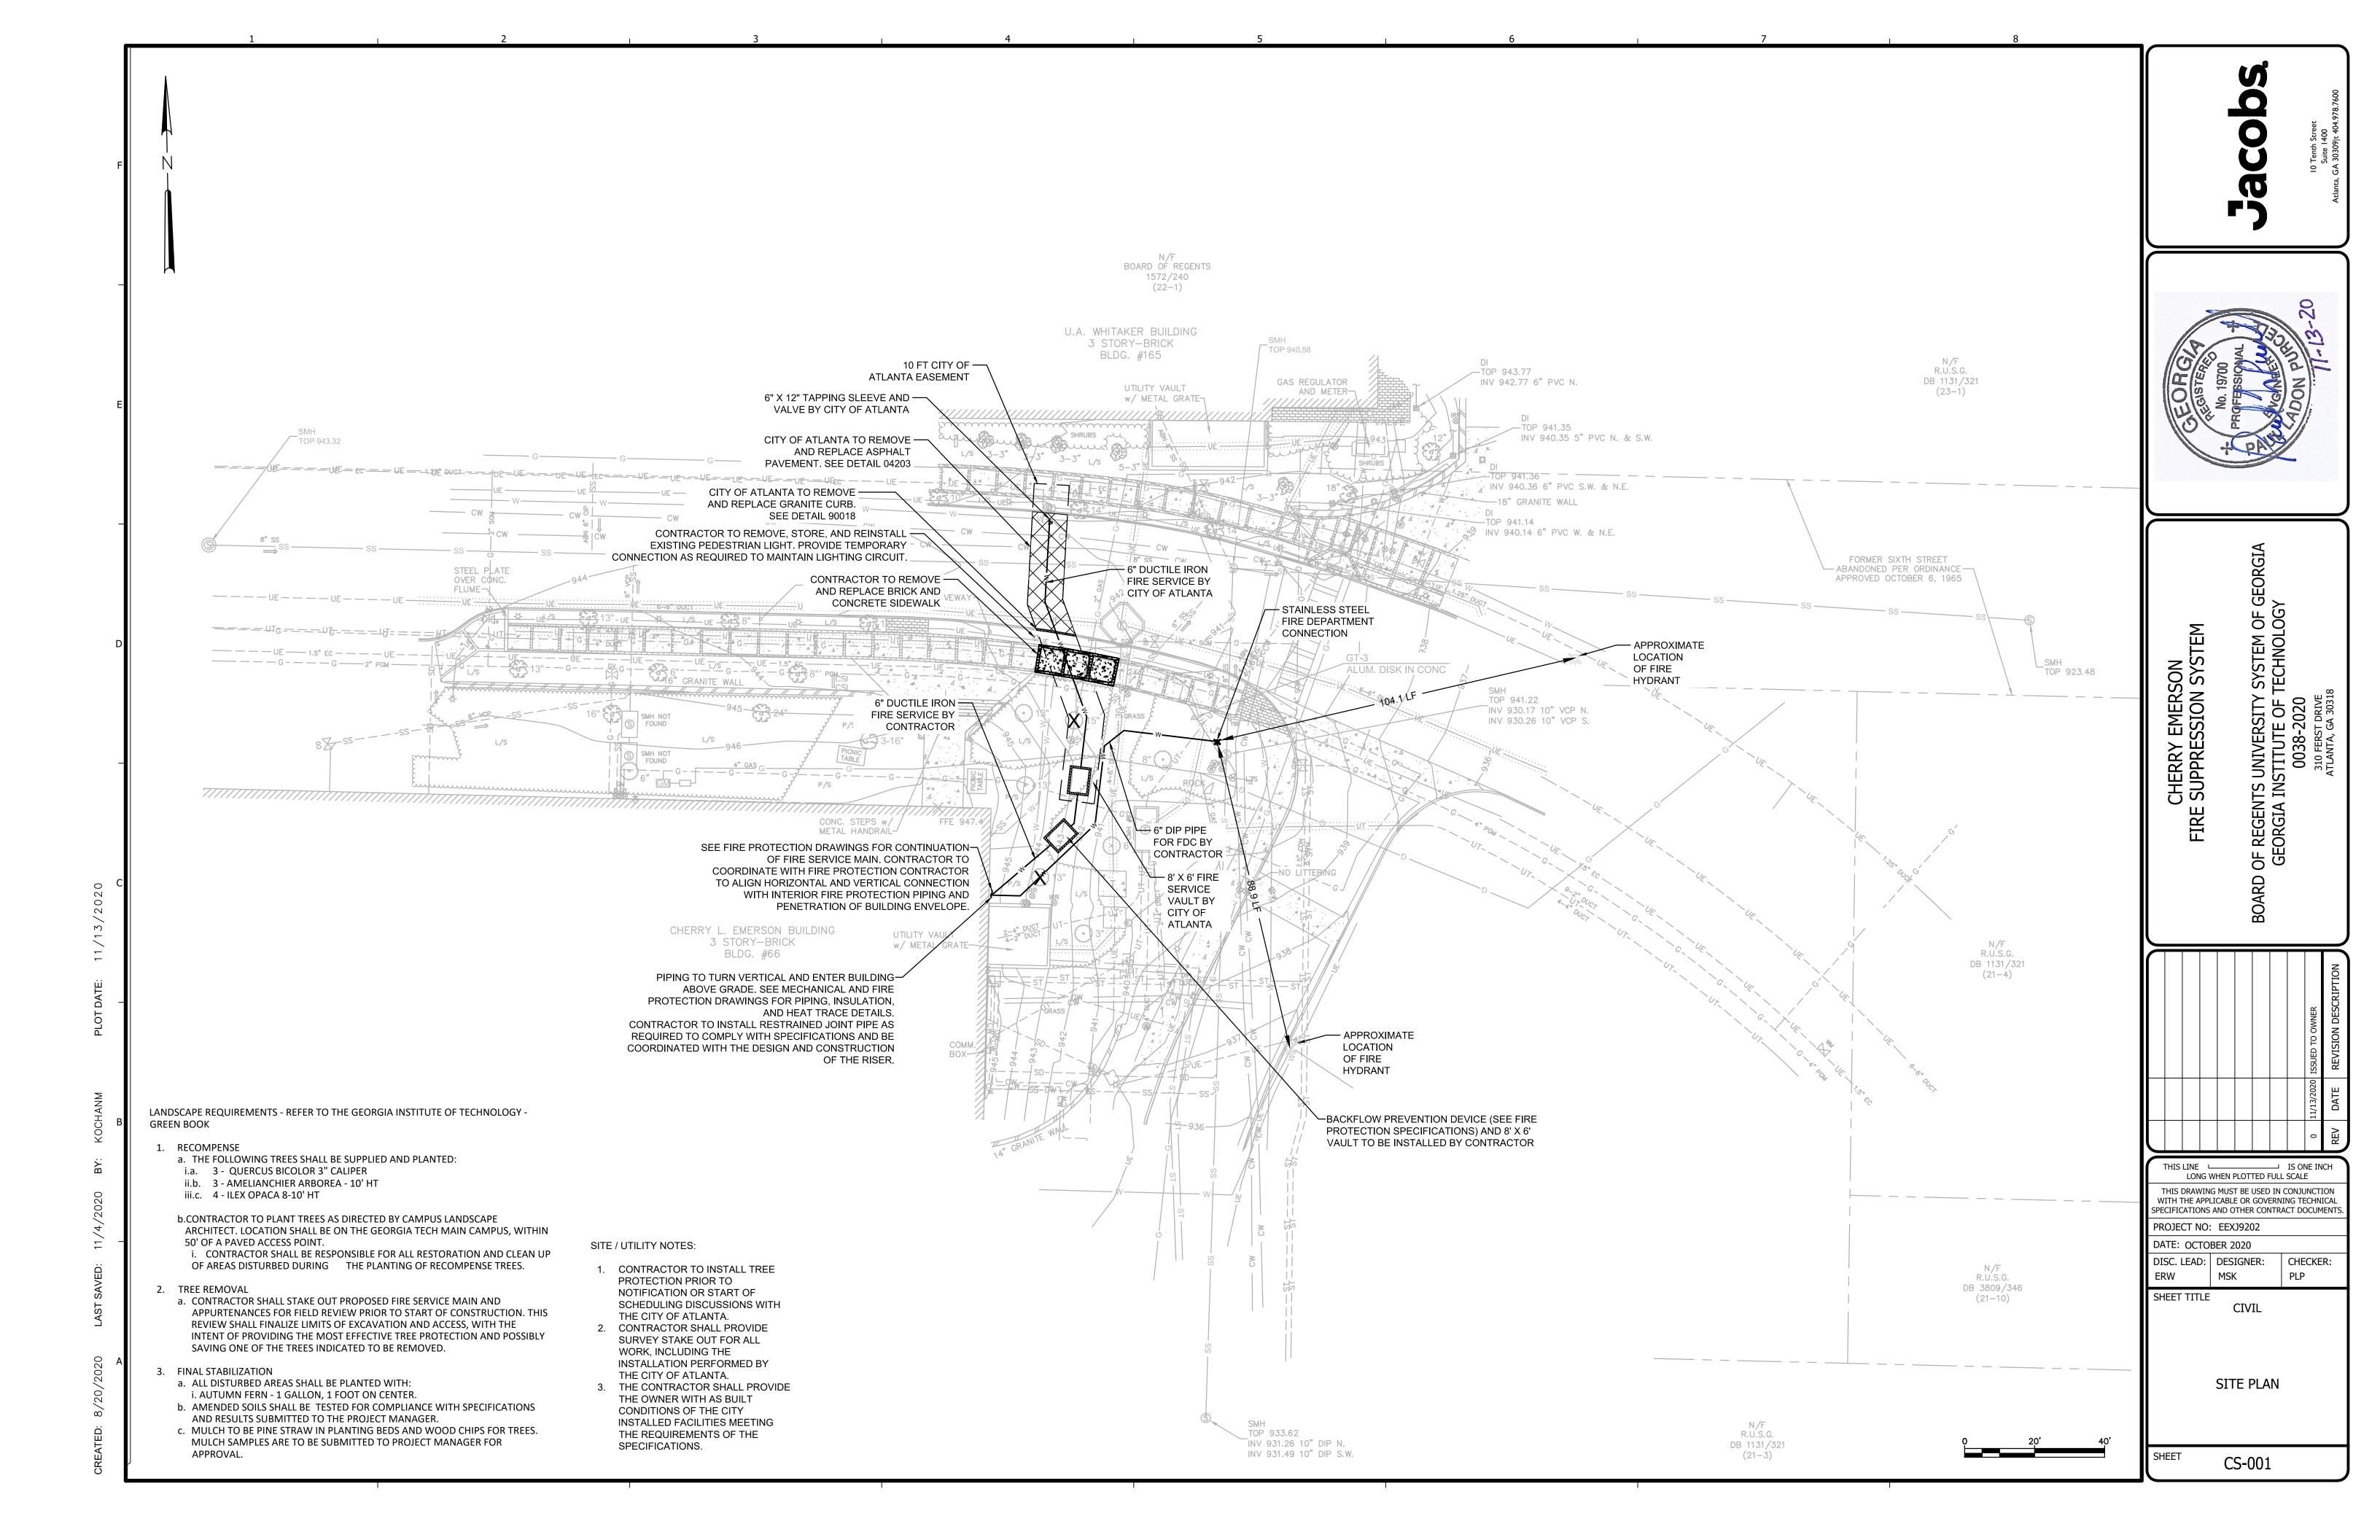

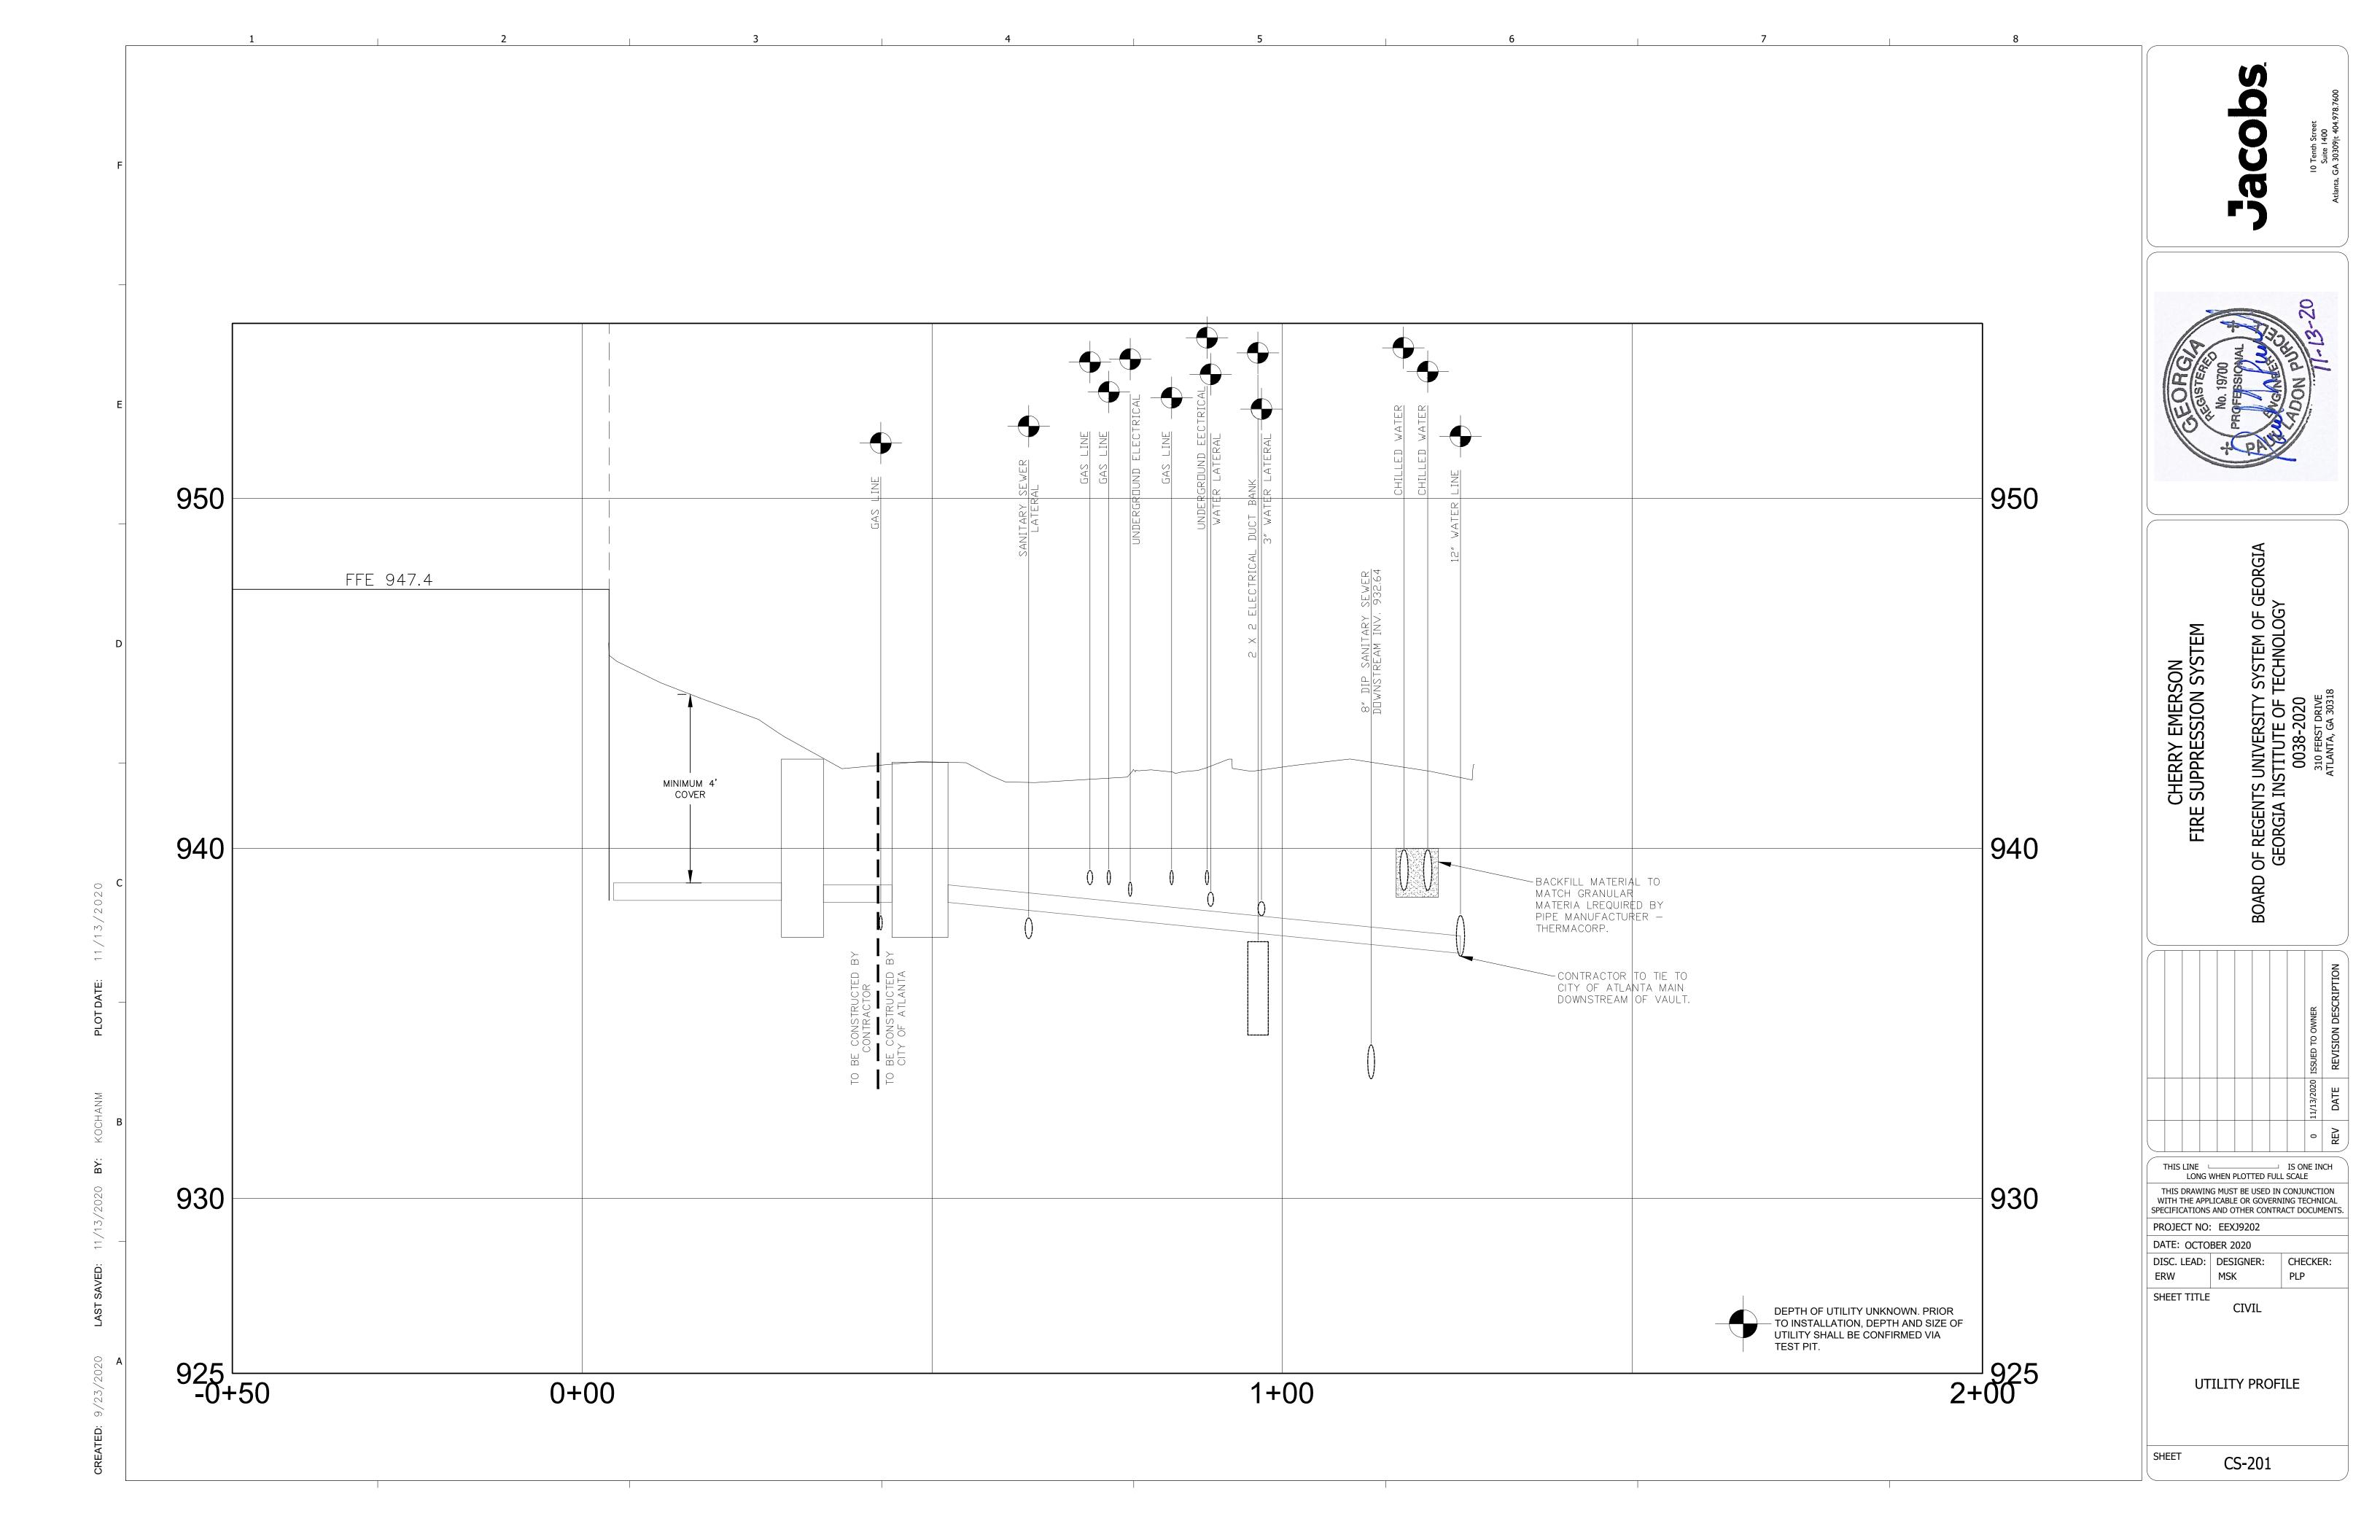

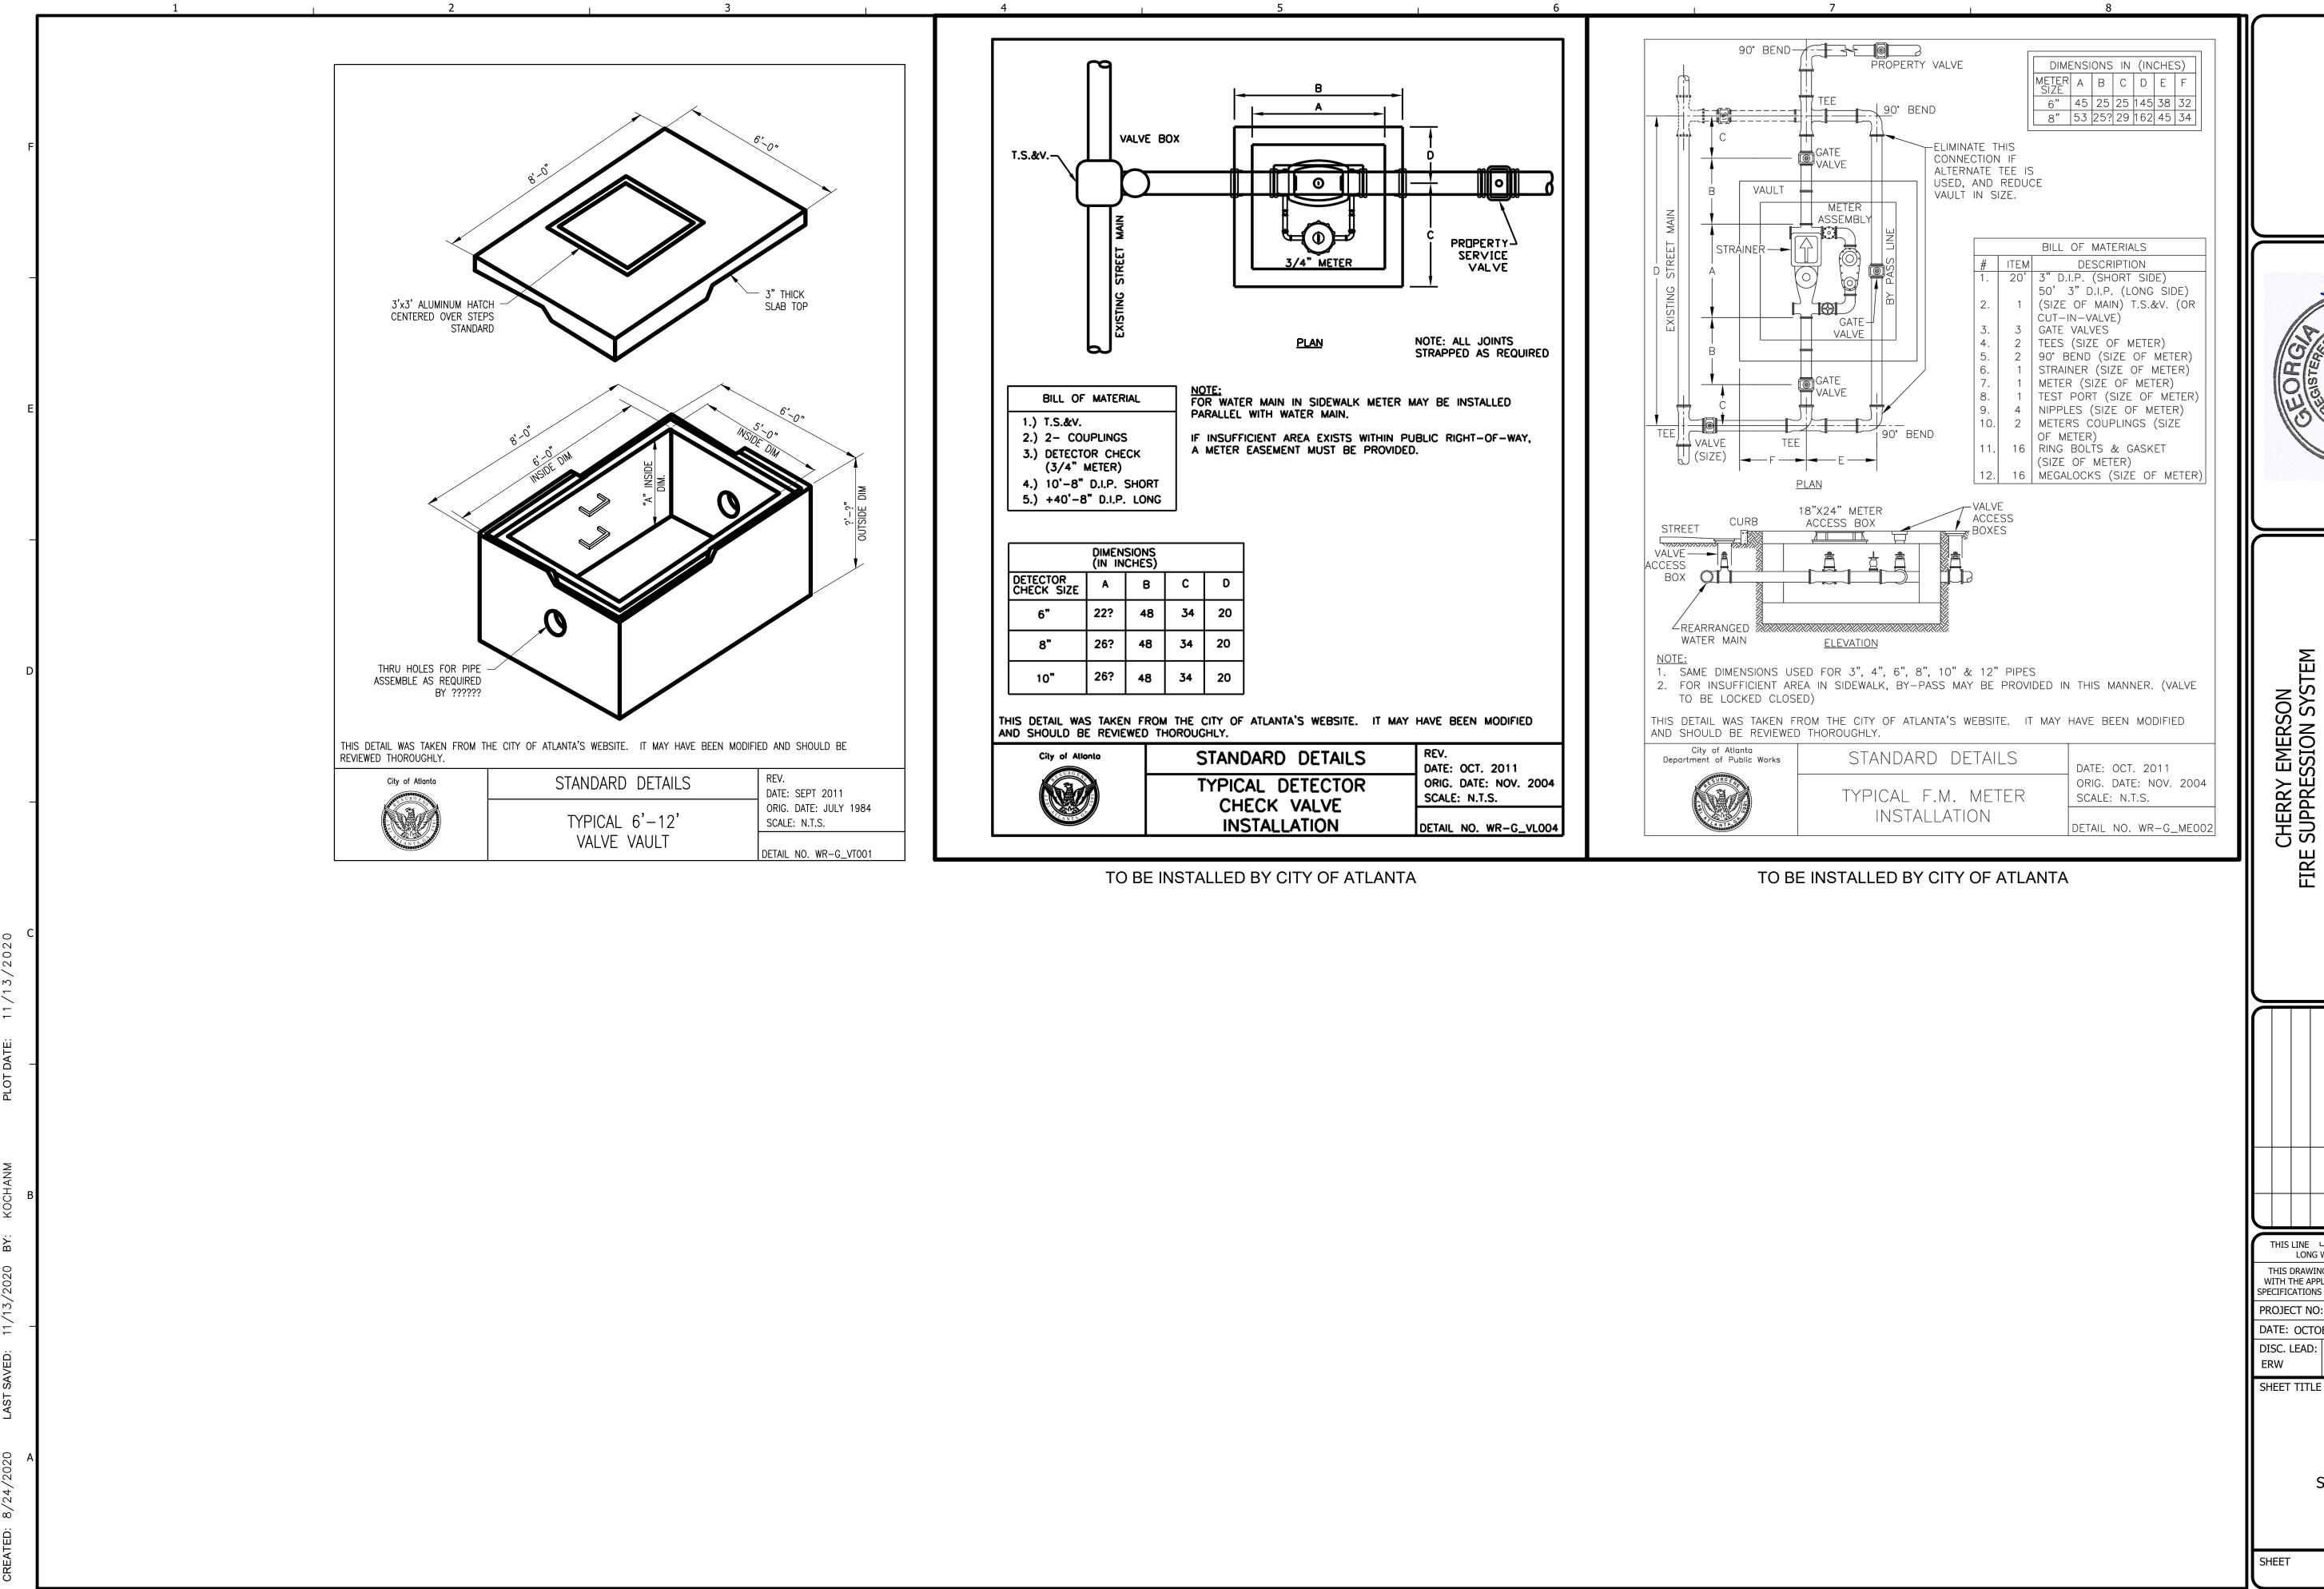

Jacob



REGENTS UNIVERSITY SYSTEM OF GEORGIA ORGIA INSTITUTE OF TECHNOLOGY 0038-2020 310 FERST DRIVE ATLANTA, GA 30318

THIS LINE L LONG WHEN PLOTTED FULL SCALE THIS DRAWING MUST BE USED IN CONJUNCTION WITH THE APPLICABLE OR GOVERNING TECHNICAL SPECIFICATIONS AND OTHER CONTRACT DOCUMENTS

PROJECT NO: EEXJ9202

DATE: OCTOBER 2020 DISC. LEAD: DESIGNER: CHECKER: MSK

SHEET TITLE CIVIL

SITE DETAILS

CS-501

