

KEY

- = C3/D4 SINGLE DOORS
- = C3/D4 DOUBLE DOORS



1 LEVEL 1
 Scale: 1/8" = 1'-0"

DEMOLITION NOTES:

- D1. REFER TO FIRE PROTECTION DRAWINGS FOR NOTES REGARDING RISER LOCATIONS THROUGH SLABS. IF FIRE MARSHAL REQUIRES A DOGHOUSE OR BELOW GRADE SUPPLY PIPE ENTRY INTO THE BUILDING, A STRUCTURAL SHEET WITH NOTES AND DETAILS WILL BE PROVIDED. VERIFY REQUIREMENTS W/ FIRE MARSHAL AND UPDATE DRAWINGS ACCORDINGLY.
- D2. REFER TO FIRE PROTECTION DRAWINGS FOR LOCATION OF DEMOLITION FOR ABOVE GRADE SUPPLY PIPE ENTRY INTO BUILDING.
- D3. REMOVE EXISTING EQUIPMENT IN CEILING AND PLAN FOR RELOCATION. COORDINATE W/ GT FACILITIES, OIT AND GT POLICE.
- D4. REMOVE EXISTING DOOR(S) EXISTING FRAMES TO REMAIN.

CONSTRUCTION NOTES

- C1 ALL EXISTING PARTITIONS, DOORS, AND CASEWORK TO REMAIN, U.N.O.
- C2 EXISTING FULL HEIGHT SMOKE DOORS TO REMAIN
- C3 PROVIDE NEW 7'-0" DOOR(S) AND PANEL ABOVE TO CEILING. REUSE EXISTING DOOR FRAME. FIELD VERIFY WIDTH OF ALL DOORS TO BE REPLACED.
- C4 EXISTING FULL HEIGHT CASED OPENING TO REMAIN.

ELECTRICAL NOTES:

- E1. ALL EXISTING ELECTRICAL TO REMAIN THROUGHOUT. REFER TO ELECTRICAL ENGINEERING DRAWINGS ASSOCIATED WITH TIE-IN TO BASE BUILDING FIRE ALARM.
- E2. GENERAL CONTRACTOR TO COORDINATE WITH GT FACILITIES, OIT AND GT POLICE TO CONFIRM APPROVAL OF RELOCATION OF ANY EXISTING WIRELESS ACCESS POINTS, SMOKE DETECTORS, OCCUPANCY SENSORS, CEILING FIRE AND AUDIO STROBES, AND CAMERAS IF CONFLICT WITH LOCATION OF NEW FIRE SPRINKLER INSTALLATION.

PLUMBING NOTES:

- PB1. PROVIDE STANDPIPE @ PENTHOUSE ON ROOF FOR GREENHOUSE COVERAGE. REFER TO ENGINEERING DRAWINGS FOR LOCATION.

FINISH NOTES:

- F1. PATCH, REPAIR AND PAINT ALL AREAS AFFECTED BY CONSTRUCTION. MATCH EXISTING FINISH.
- F2. ALL COMPLETED REPAIRS AND FINISHES SHALL MAINTAIN PROPER FIRE RATINGS.
- F3. PATCH EXISTING FLOORING AFFECTED BY CONSTRUCTION. INSTALL RUBBER BASE TO MATCH EXISTING.
- F4. PATCH EXISTING FLOORING AFFECTED BY CONSTRUCTION. INSTALL RUBBER BASE TO MATCH EXISTING.


FINISHES

- RUBBER BASE: JOHNSONITE 40 BLACK, 6" ROLL GOODS
- PAINT: TYPICAL WALLS: SHERWIN WILLIAMS SW7636 ORIGAMI WHITE, EGGSHELL FINISH
- DOOR FRAMES, STAIR COMPONENTS - STEEL RAILINGS, STRINGERS AND RISERS: SHERWIN WILLIAMS SW1163 TIN LIZZIE, SEMI-GLOSS FINISH
- FINISH SPECIFICATIONS PROVIDED BY GT FACILITIES. CONTRACTOR TO CONFIRM FINISHES SPECIFIED MATCH EXISTING FINISHES IN THE FIELD.

LEGEND


- EXISTING EXTERIOR WALL
- EXISTING INTERIOR WALL
- EXISTING STOREFRONT/WINDOW
- EXISTING DOOR
- NEW DOOR(S) WITH PANEL ABOVE

Attachment 4
GT Cherry Emerson - Door Replacement
Locations
Dated 1/14/21

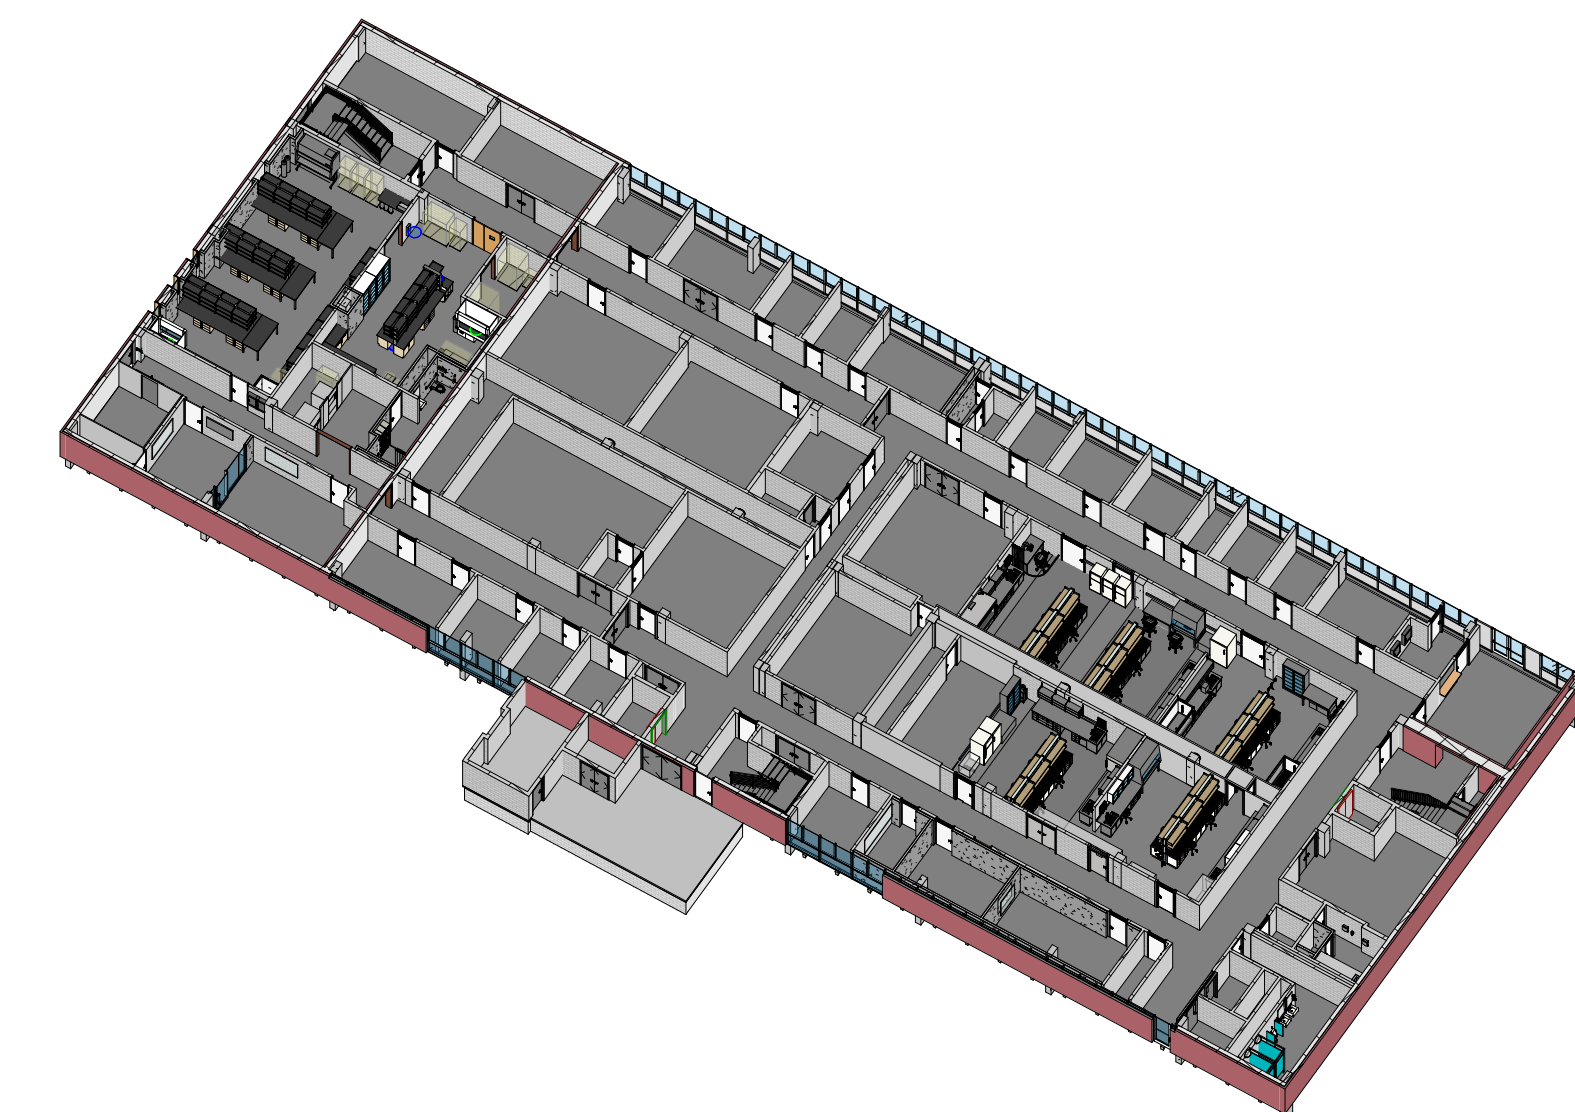

2 LEVEL 1

Cherry Emerson Building (066)
Fire Sprinkler System Addition
The Georgia Institute of Technology
 310 Ferst Dr NW,
 Atlanta, GA 30332

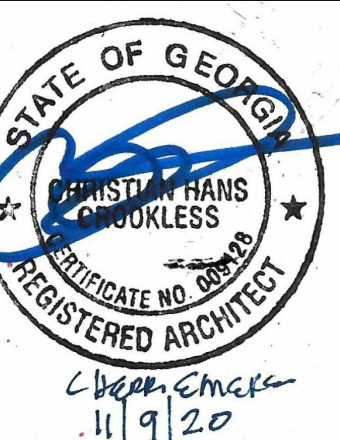


corr. no.	date
119060	9-29-20
drawn by	checked by
FJJC	JCC/HC


LEVEL 1 - FLOOR PLANS

sheet no.

TA-0.1

KEY

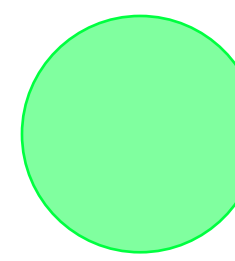


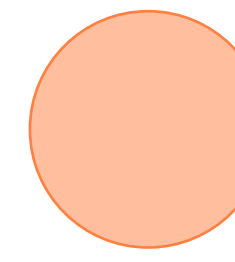

 = C3/D4 SINGLE DOORS


 = C3/D4 DOUBLE DOORS

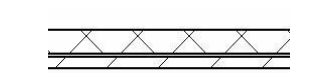

1 LEVEL 2
Scale: 1/8" = 1'-0"

LEGEND
ALL PARTITIONS WALLS, WINDOWS AND DOORS ARE EXISTING TO REMAIN.

-  EXISTING EXTERIOR WALL
-  EXISTING INTERIOR WALL
-  EXISTING STOREFRONT/WINDOW
-  EXISTING DOOR
-  NEW DOOR(S) WITH PANEL ABOVE

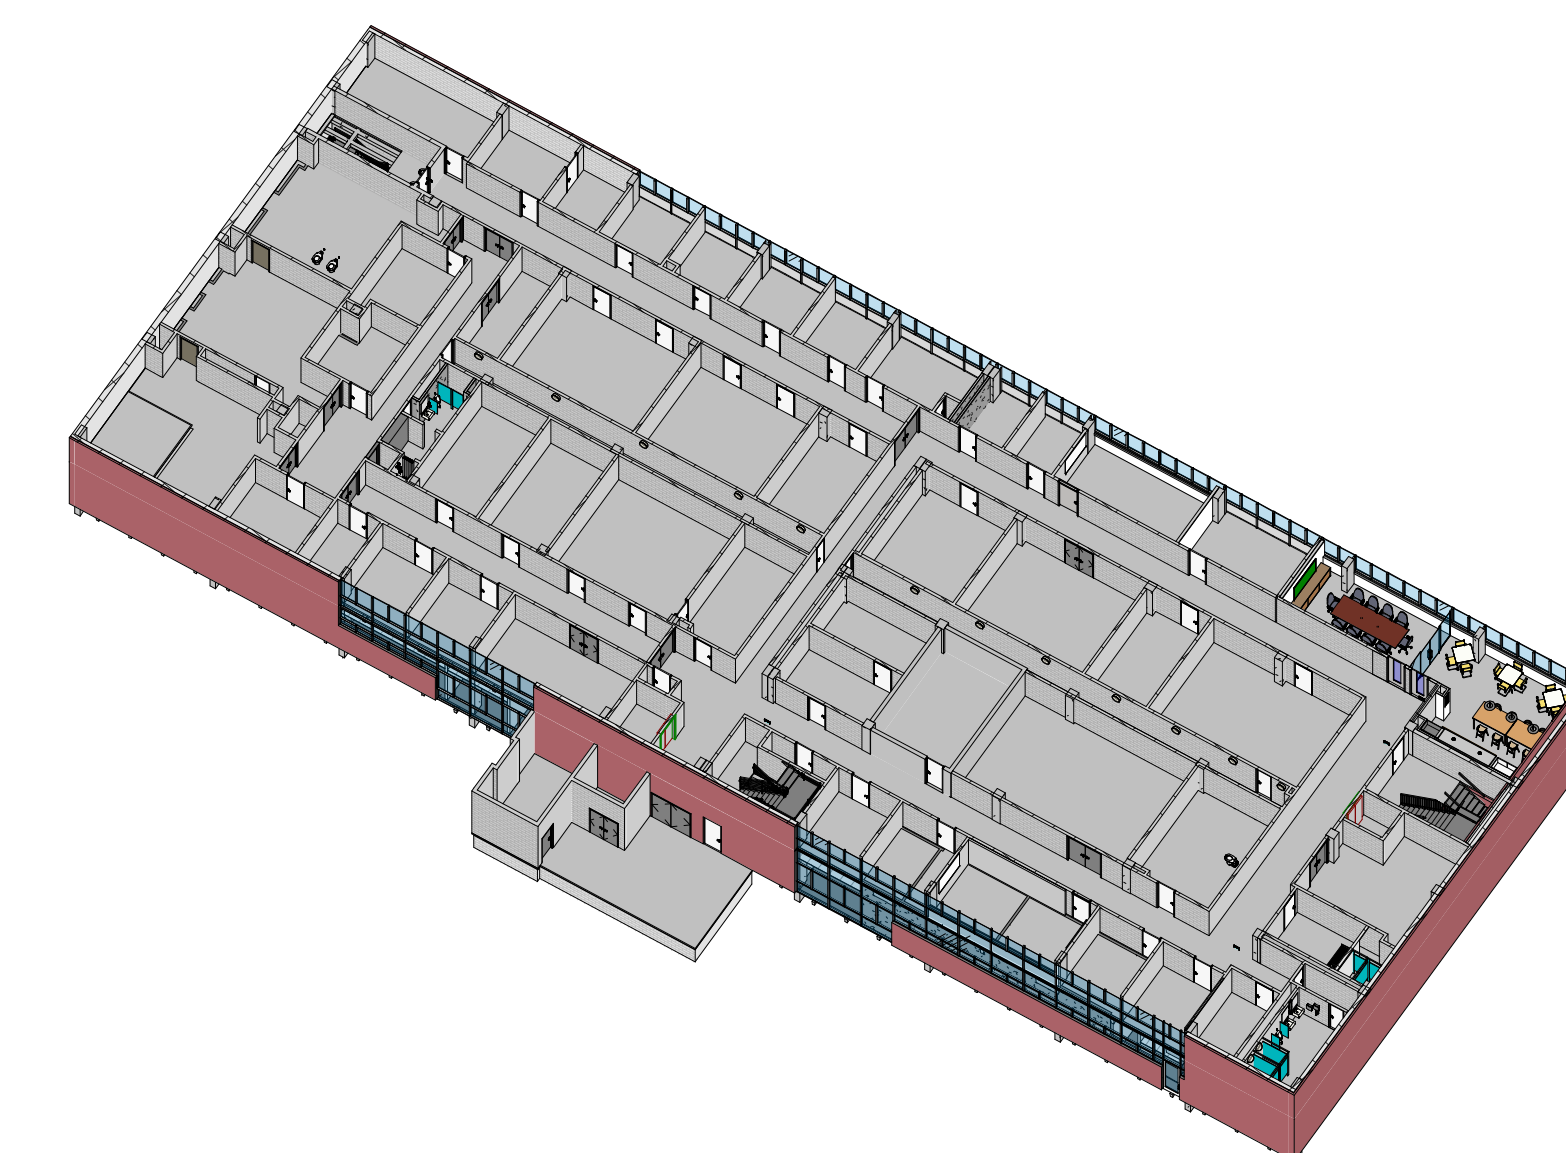


2 LEVEL 2

Attachment 4
GT Cherry Emerson - Door Replacement Locations
Dated 1/14/21

REVISIONS		
date	no.	description
ISSUE RECORD		
date	description	issue
9-24-20	75% ISSUED FOR PRICING SET REVIEW	
11-9-20	ISSUED FOR PERMITTING AND CONSTRUCTION	

Cherry Emerson Building (066)
Fire Sprinkler System Addition
The Georgia Institute of Technology
310 Ferst Dr NW,
Atlanta, GA 30332

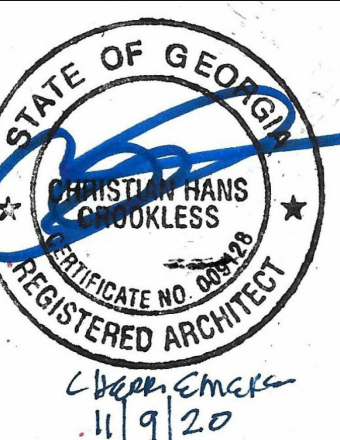

This drawing is the property of SWI Studio, Inc. and is not to be reproduced or copied in whole or in part or used in any way without the written permission of SWI Studio, Inc.

corr. no.	date
119050	9-29-20
drawn by	checked by
FJJC	JCC/CHC


Sheet Description
LEVEL 2 - FLOOR PLANS


Sheet no.

TA-0.2


KEY

 = C3/D4 SINGLE DOORS

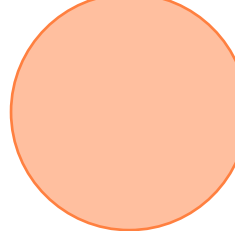
 = C3/D4 DOUBLE DOORS

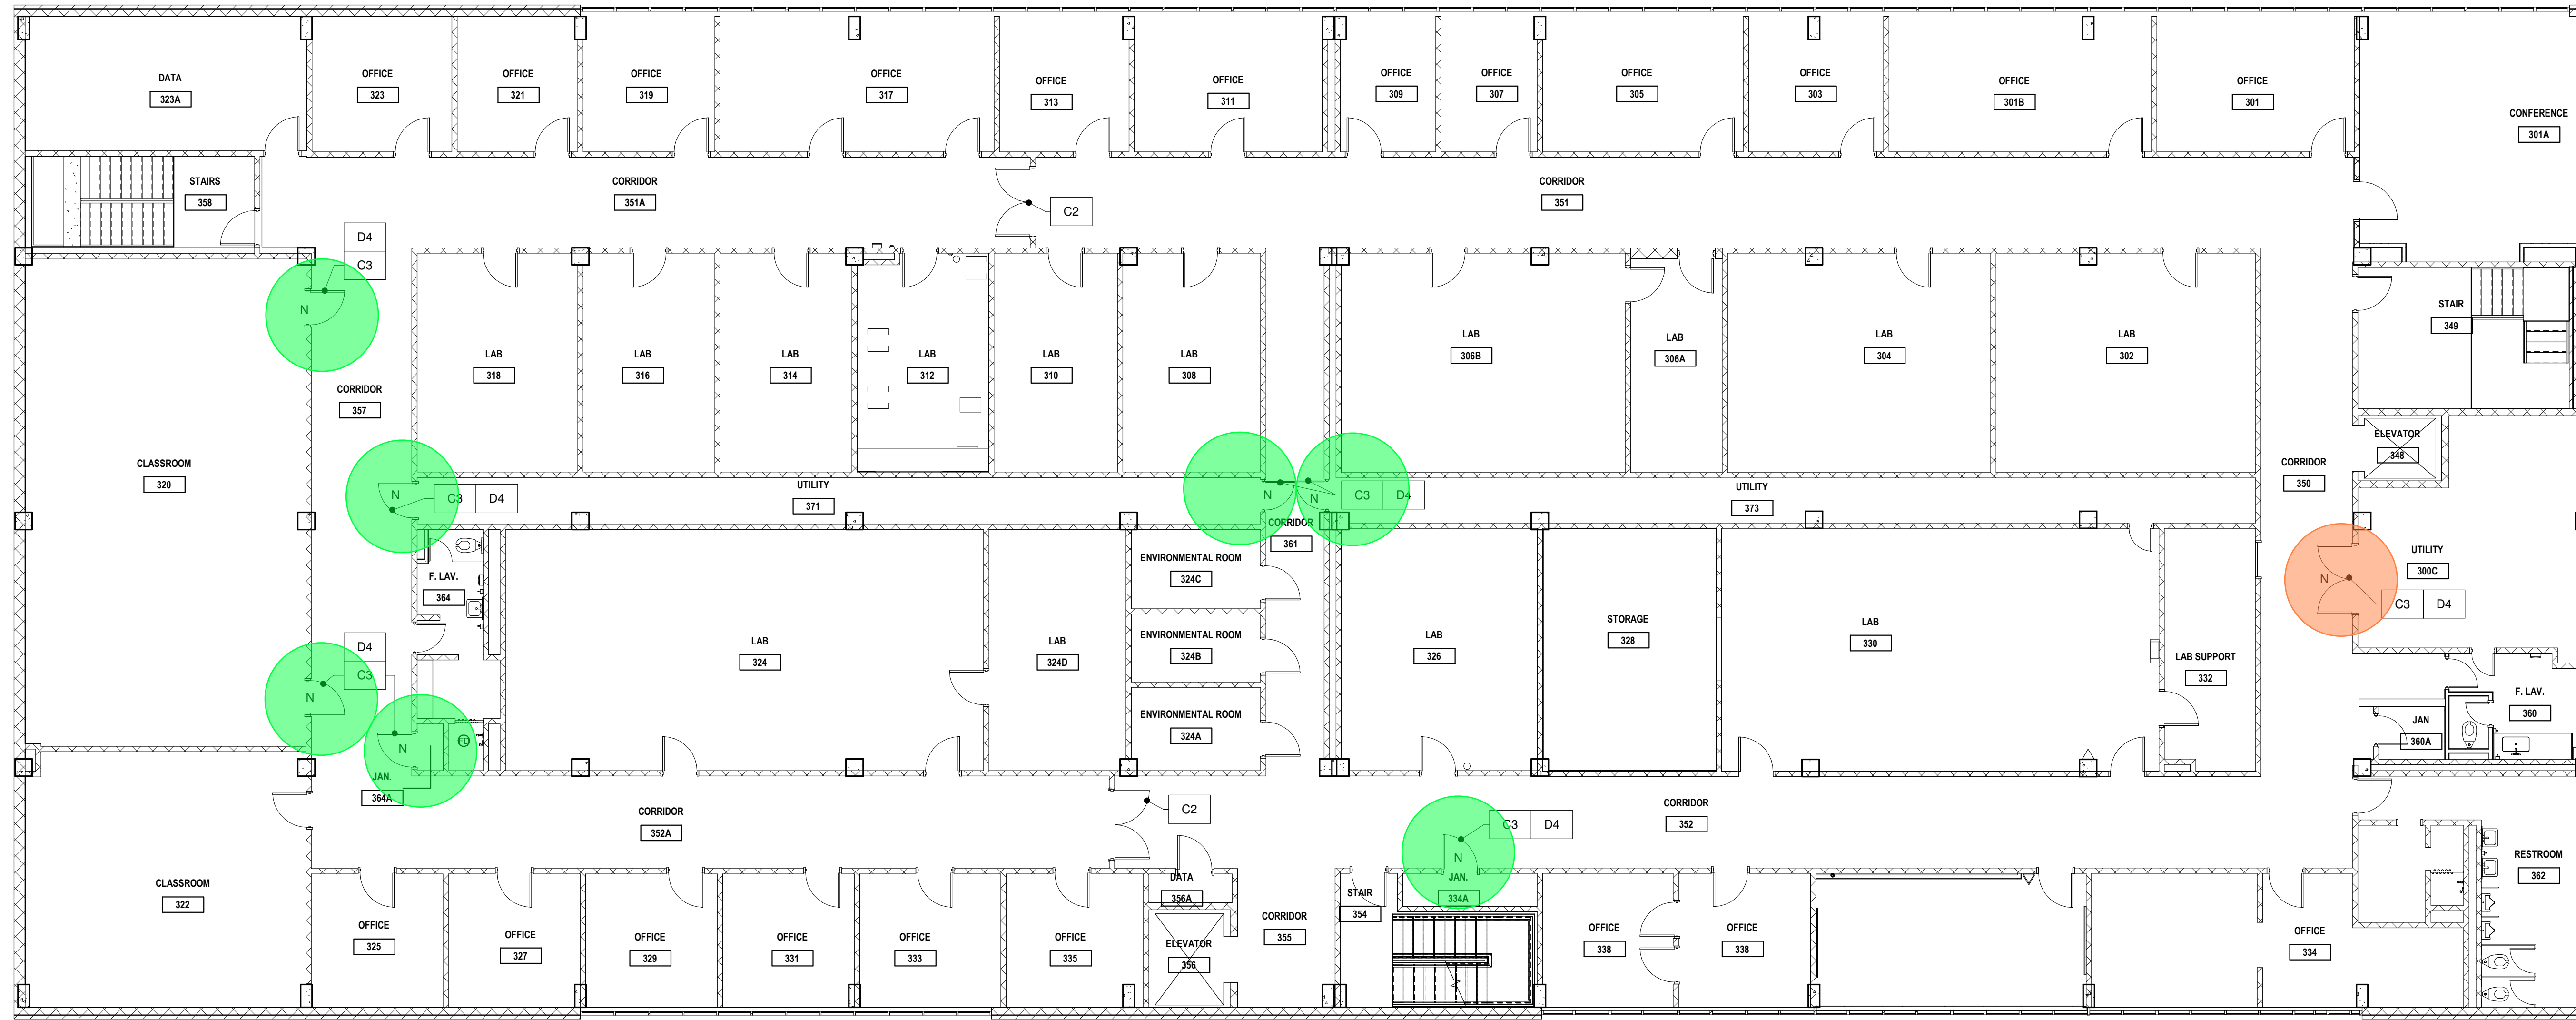

1 LEVEL 3
Scale: 1/8" = 1'-0"

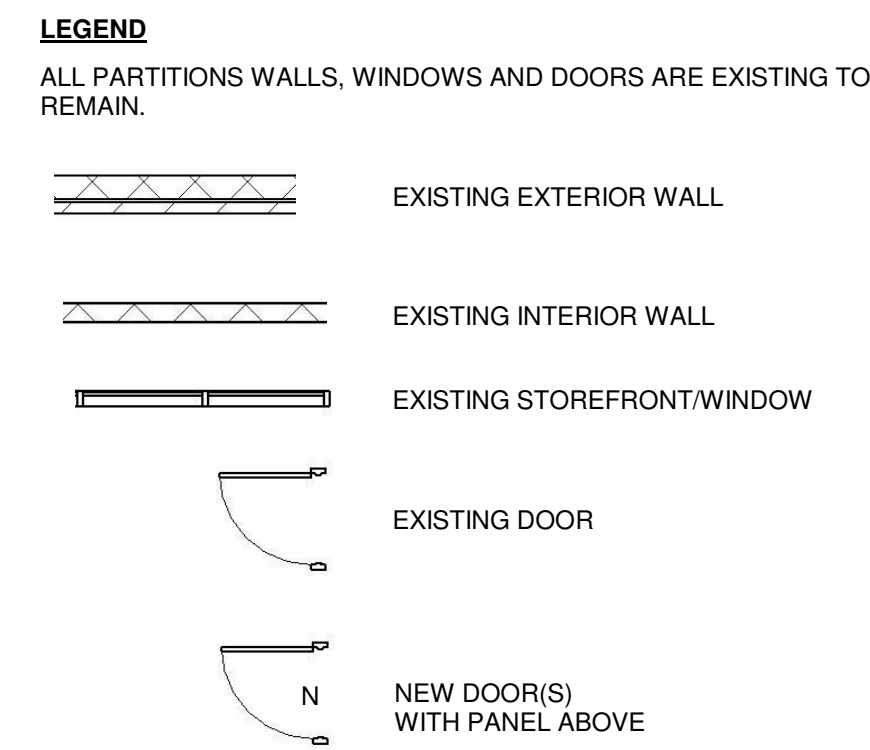


Attachment 4
GT Cherry Emerson - Door Replacement Locations
Dated 1/14/21

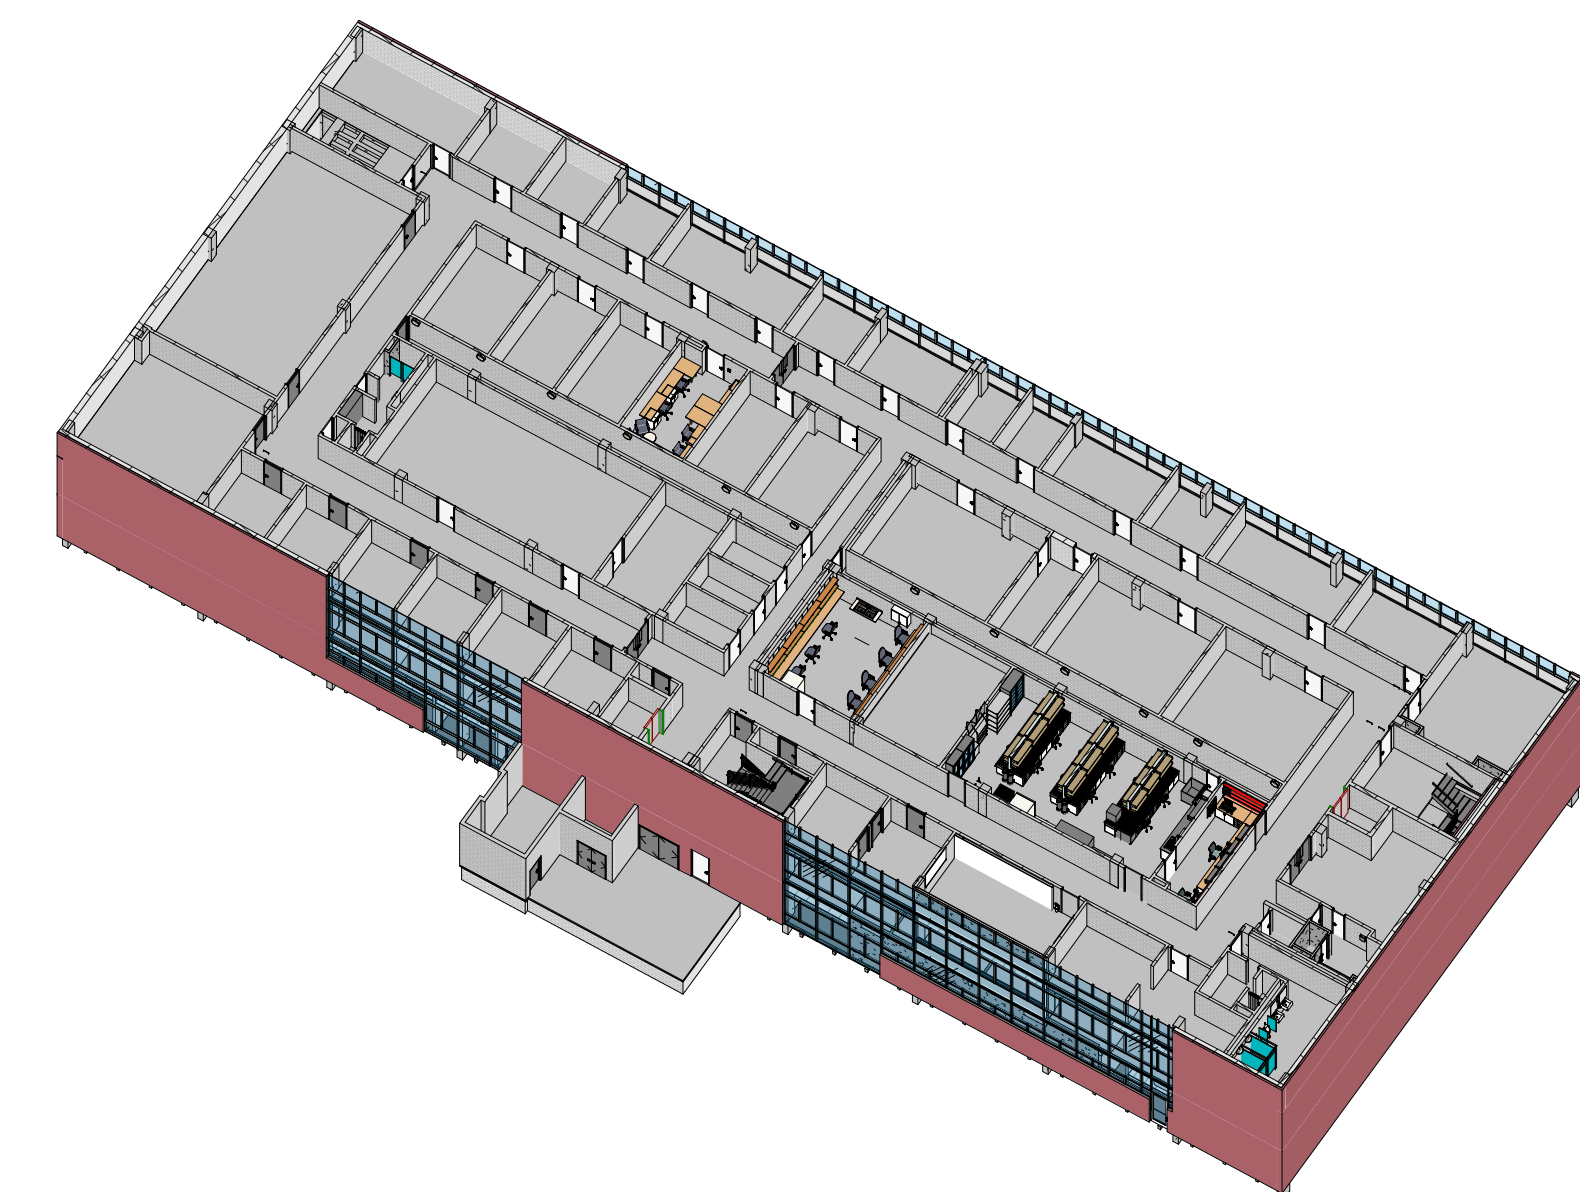

2 LEVEL 3

**Cherry Emerson Building (066)
Fire Sprinkler System Addition**
The Georgia Institute of Technology
310 Ferst Dr NW,
Atlanta, GA 30332

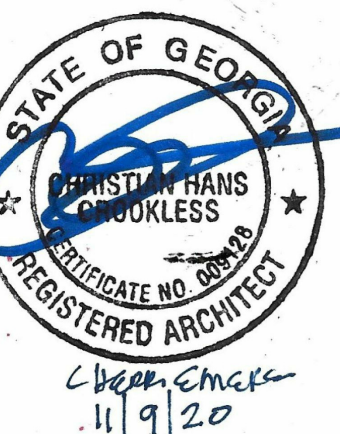

This drawing is the property of SWI Studio, Inc. and is not to be reproduced or copied in whole or in part or used in any way without the written permission of SWI Studio, Inc.

corr. no.	date
119060	9-29-20
drawn by	checked by
FJJC	JCC/CHC

Sheet Description
LEVEL 3 - FLOOR PLANS

Sheet no.

TA-0.3